

GENERAL

CVIII-TS TITLE SHEET CIVIL

CVIII-100	EXISTING SITE CONDI
CVIII-101	EROSION AND SEDIM
CVIII-200	SITE PLAN
CVIII-300	DETAILS
CVIII-301	DETAILS

ARCHITECT/ENGINEER




860 Hooper Road Endwell, New York 13760 Tel: 607.231.6600 Fax: 607.231.6650 Email: mail@delta-eas.com www.delta-eas.com

SSC CORTLANDVILLE III LLC

4240 BELL CREST DRIVE CORTLAND, NY 13045 DELTA PROJECT NO. 2020.260.001 ORIGINAL SUBMISSION JULY 22, 2020 REVISED SUBMISSION AUGUST 17, 2020 PLANNING BOARD

INDEX OF DRAWINGS

DITIONS IENT CONTROLS PLAN

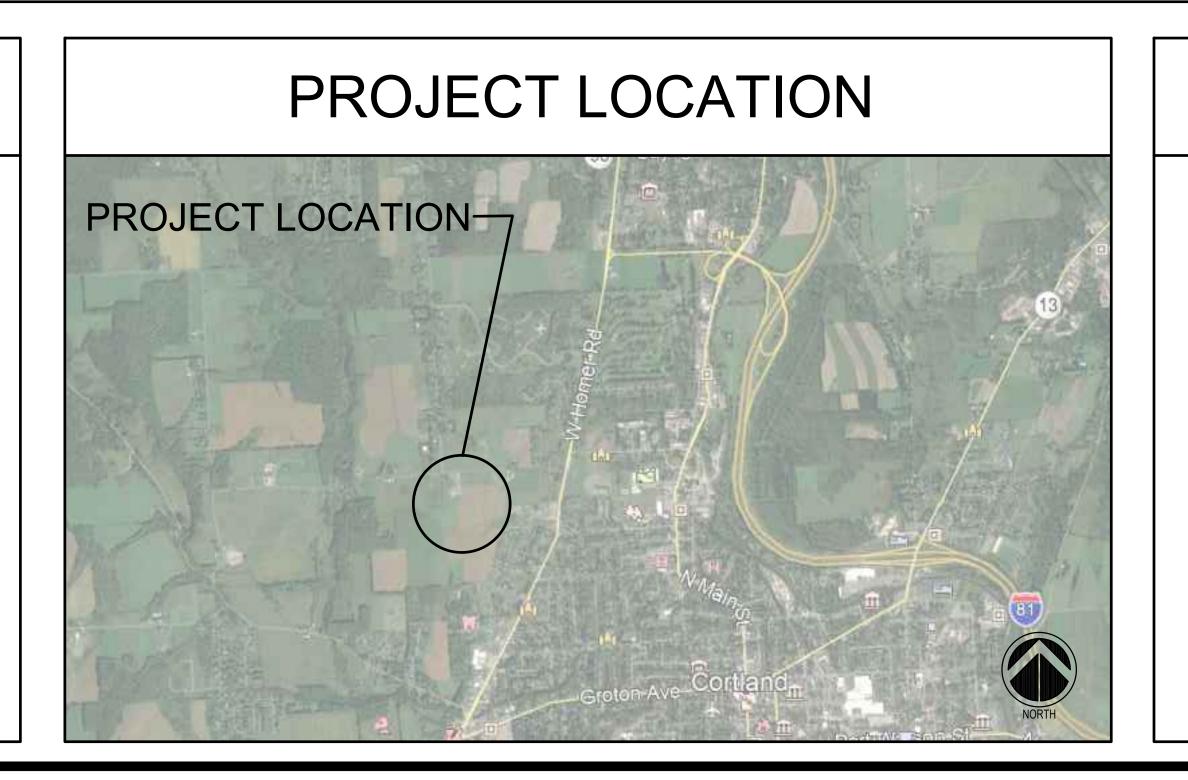

OWNER



SSC Cortlandville III LLC 334 Arapahoe Ave Boulder, CO 80302 Tel: 561.866.8234 Email: john@summitsolarcapital.com

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- WETLANDS WERE RECENTLY MAPPED AND UNKNOWN TO STATE AND FEDERAL AGENCIES.

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SSC Cortlandville III LLC 334 Arapahoe Ave Boulder, Colorado 80302 Tel: 561.866.8234 Email: john@summitsolarcapital.com		
Key Plan		
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NOTFORCONSTRUCTION		
1 Revised Solar Layout No. Revision Project Name SSC CORTLANDVILLE I	8/17/2020 Date	
TOWN OF CORTLANDVILLE, NEW YORK STA	ſE	
ENGINEERS, ARCHITECTS, & SURVEYORS 860 Hooper Road Endwell, New York 13760 Tel: 607.231.6600 Fax: 607.231.6650 Email: mail@delta-eas.com www.delta-eas.com		
Project No. 2020. UNAUTHORIZED ALTERA IS A VIOLATION LAW, SECT	NG BOARD 261.001 TION OF THIS DRAWING HE NEW YORK STATE ON 7200, SUBDIVISION	
Date 2020 Drawing Title EXISTING SITE CONDITION	0.07.22	
Drawing No.)0	




EXISTING CONDITIONS LEGEND:	
PROPERTY LINE	
SETBACK LINE	
EXISTING GROUND CONTOUR	
WETLAND BOUNDARY	
EXISTING OVERHEAD ELECTRIC LINE	—— он —— он —— он ——
EXISTING PAVEMENT AREA	
EXISTING TREE LINE	

EROSION AND SEDIMENT CONTROL LEGEND:		
SILT FENCE		
PERVIOUS ACCESS ROAD		
STABILIZED CONSTRUCTION ENTRANCE		
25' VEGETATIVE BUFFER	· ·	
CLEAR AND GRUB AREA		

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(#)	KEY NOTES			
$\begin{array}{c} \hline 1 \\ \hline 2 \\ \end{array}$	PROVIDE SILT FENCE. ADJUST AS NEEDED AS LAND CLEARING PROGRESSES, TYP. SEE DETAIL 2/CVIII-301. PROVIDE STABILIZED CONSTRUCTION ENTRANCE. SEE DETAIL 1/CVIII-301.			
$\langle 3 \rangle$	MAINTAIN 25' VEGETATED BUFFER WITH SELECTIVE CLEARING AT WETLAND BOUNDARIES, TYP.			
<u></u>	CLEARING AND GRUBBING AREA, TYP.		0' 75'	150'
			SCALE: 1'	'=150'

SSC Cortlandville III LLC 334 Arapahoe Ave Boulder, Colorado 80302 Tel: 561.866.8234
Email: john@summitsolarcapital.com
Key Plan
NOTFORCONSTRUCTION
1 Revised Solar Layout 8/17/2020
No. Revision Date Project Name
SSC CORTLANDVILLE III LLC
TOWN OF CORTLANDVILLE, NEW YORK STATE
ENGINEERS, ARCHITECTS, & SURVEYORS 860 Hooper Road Endwell, New York 13760 Tel: 607.231.6600 Fax: 607.231.6650 Email: mail@delta-eas.com www.delta-eas.com
Seal Phase PLANNING BOARD
Project No. 2020.261.001
UNAUTHORIZED ALTERATION OF THIS DRAWING IS A VIOLATION OF THE NEW YORK STATE EDUCATION LAW, SECTION 7209, SUBDIVISION 2.
Date 2020.07.22 Drawing Title
EROSION AND SEDIMENT CONTROLS PLAN
Drawing No.

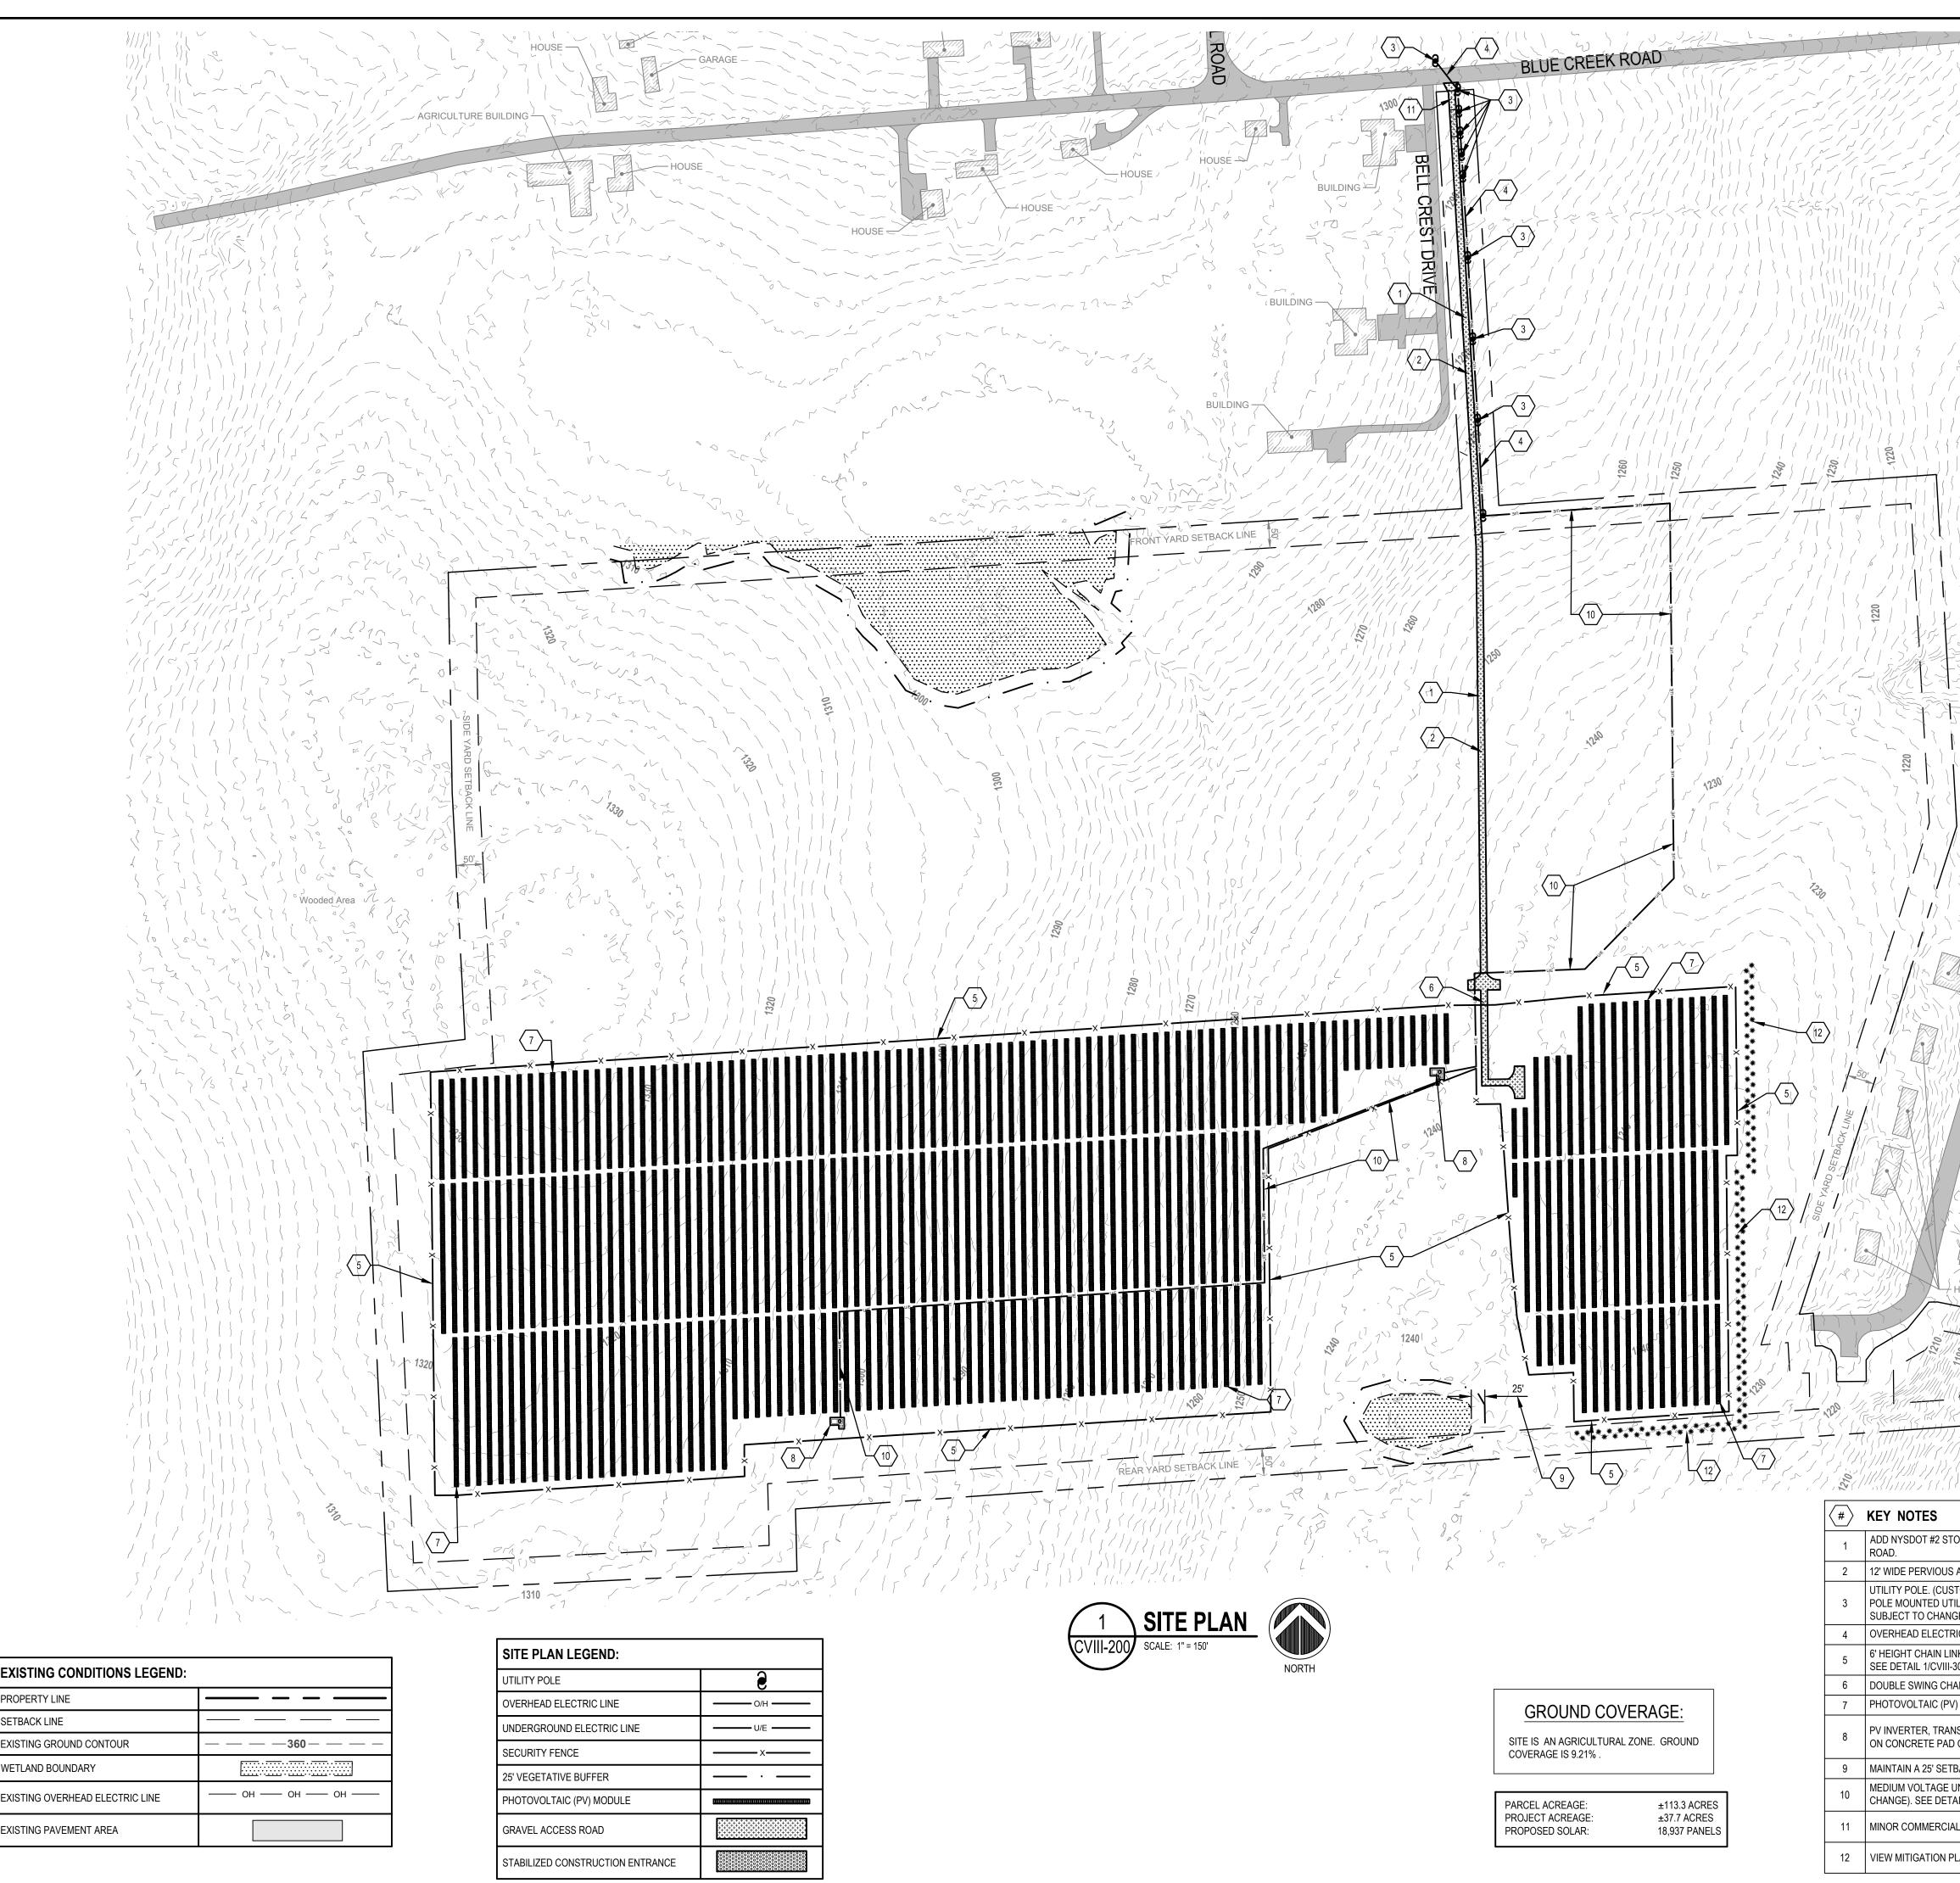

EXISTING CONDITIONS LEGEND:	
PROPERTY LINE	
SETBACK LINE	
EXISTING GROUND CONTOUR	360
WETLAND BOUNDARY	······································
EXISTING OVERHEAD ELECTRIC LINE	—— он —— он —— он ——
EXISTING PAVEMENT AREA	

SITE PLAN LEGEND:	
UTILITY POLE	9
OVERHEAD ELECTRIC LINE	O/H
UNDERGROUND ELECTRIC LINE	
SECURITY FENCE	x
25' VEGETATIVE BUFFER	·
PHOTOVOLTAIC (PV) MODULE	
GRAVEL ACCESS ROAD	*****
STABILIZED CONSTRUCTION ENTRANCE	

TONE AS REQUIRED TO STABILIZE EXISTING SITE ACCESS
S ACCESS DRIVE. SEE DETAIL 3/CVIII-301.
STOMER LOAD BREAK DISCONNECT, CUSTOMER RECLOSER, TILITY METER AND CUSTOMER RISER POLE) FINAL LOCATION IGE.
RIC LINE. (FINAL LOCATION SUBJECT TO CHANGE)
NK SECURITY FENCE WITH 12" OF 3 - STRAND BARBED WIRE. -300.
IAIN LINK FENCE GATE. SEE DETAIL 2/CVIII-300.
V) MODULE,TYP.
NSFORMER AND NEUTRAL GROUND REACTOR EQUIPMENT SET O OR DRIVEN PILE FOUNDATION. SEE DETAIL 4/CVIII-300.
FBACK FROM WETLANDS.
UNDERGROUND ELECTRIC LINE. (FINAL LOCATION SUBJECT TO AIL 3/CVIII-300.
AL DRIVEWAY. SEE DETAIL 4/CVIII-301.
PLANTING. SEE DETAIL 6/CVIII-301.

300'


75'

SCALE: 1"=150'

150'




SUMMIT SOLAR
SSC Cortlandville III LLC 334 Arapahoe Ave Boulder, Colorado 80302 Tel: 561.866.8234 Email: john@summitsolarcapital.com
Key Plan
NOTFORCONSTRUCTION
1 Revised Solar Layout 8/17/2020 No. Revision Date Project Name
SSC CORTLANDVILLE III LLC
TOWN OF CORTLANDVILLE, NEW YORK STATE EXAMPLE 1 A CONTRACT OF CONTACT OF CONT
Seal Phase PLANNING BOARD Project No. 2020.261.001 UNAUTHORIZED ALTERATION OF THIS DRAWING IS A VIOLATION OF THE NEW YORK STATE EDUCATION LAW, SECTION 7200, SUBDIVISION 2. Date 2020.07.22
Drawing Title SITE PLAN
Drawing No. CVIII-200

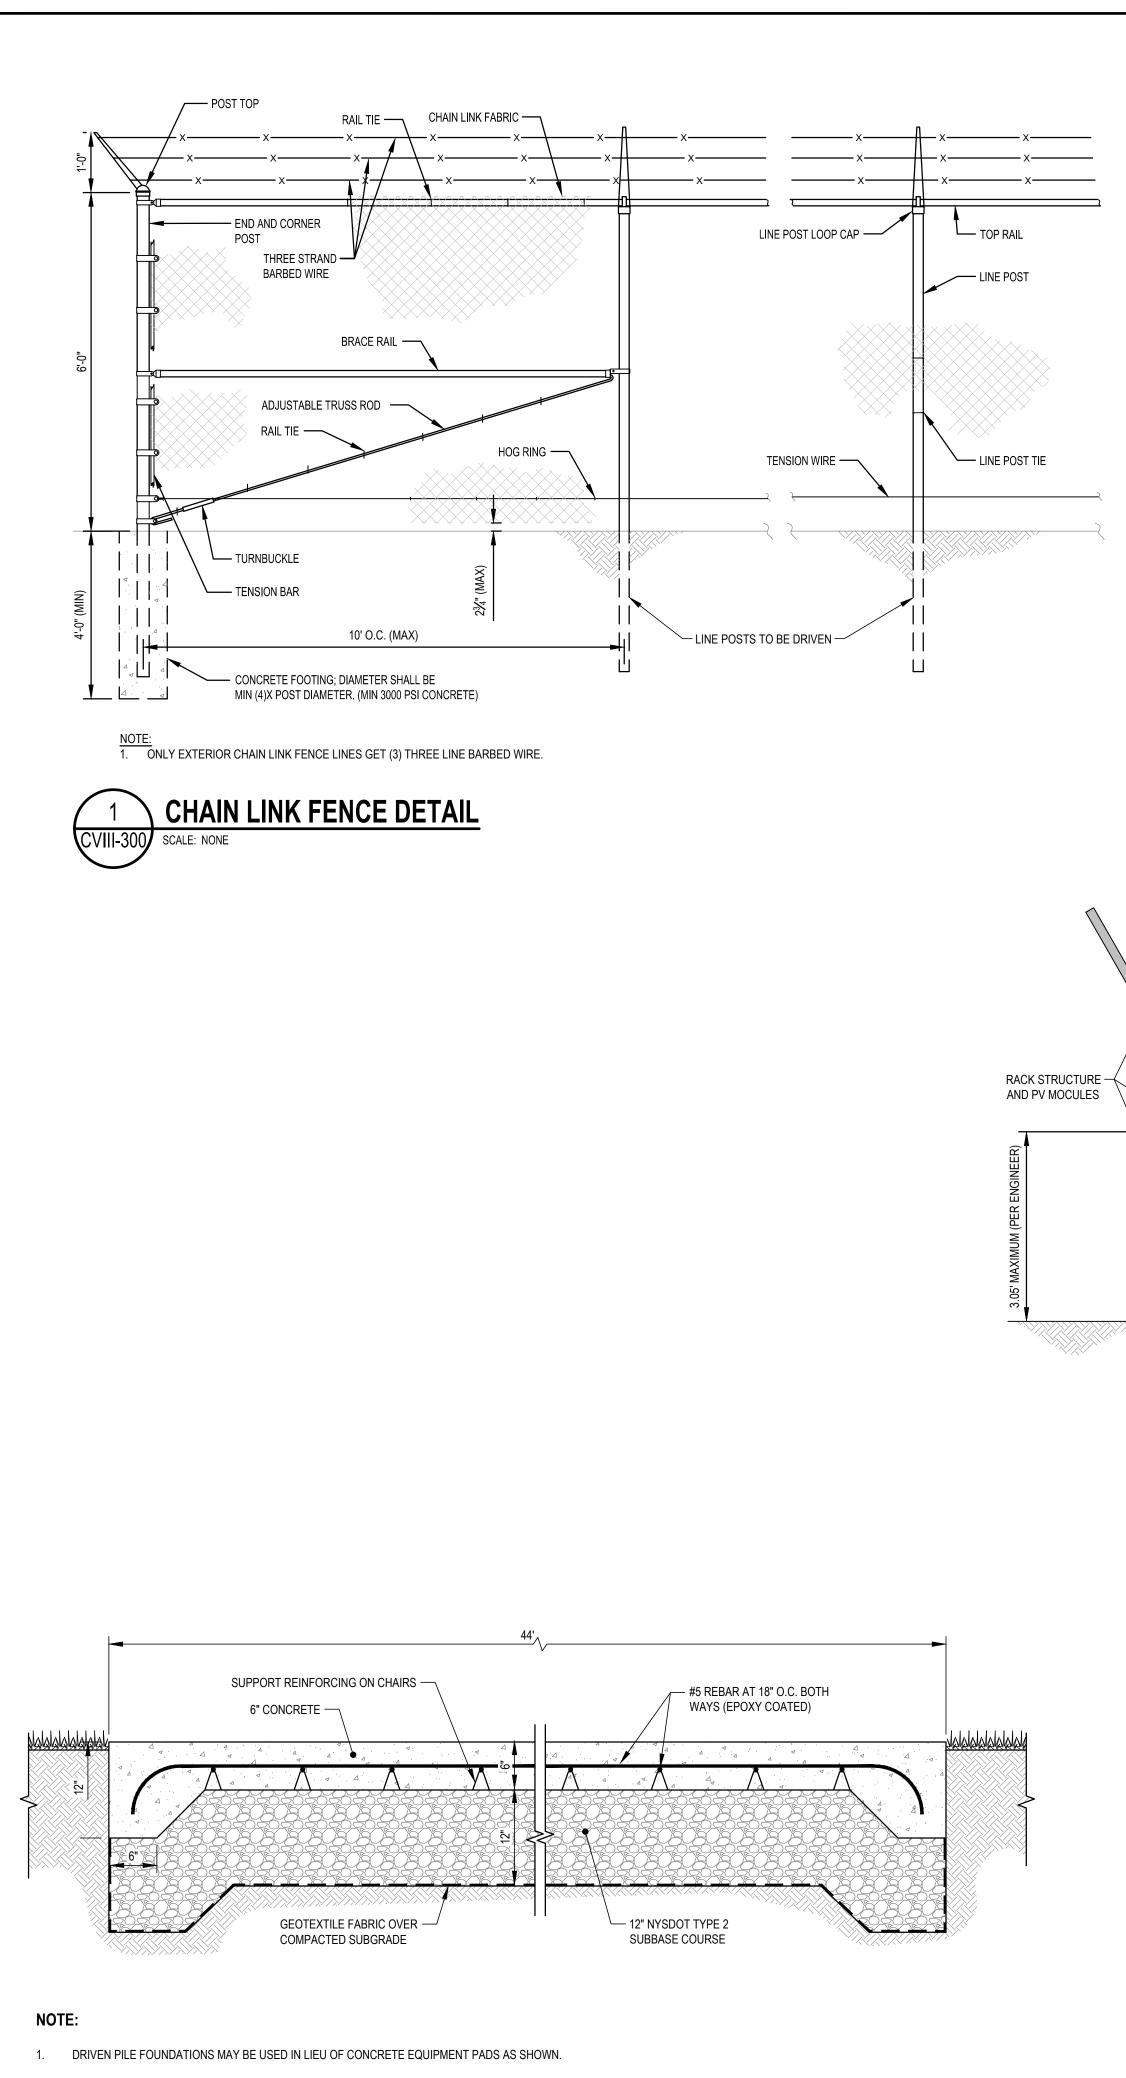

THICKENED EDGE 6" THICK CONCRETE PAD DETAIL 5

CVIII-300 SCALE: NONE

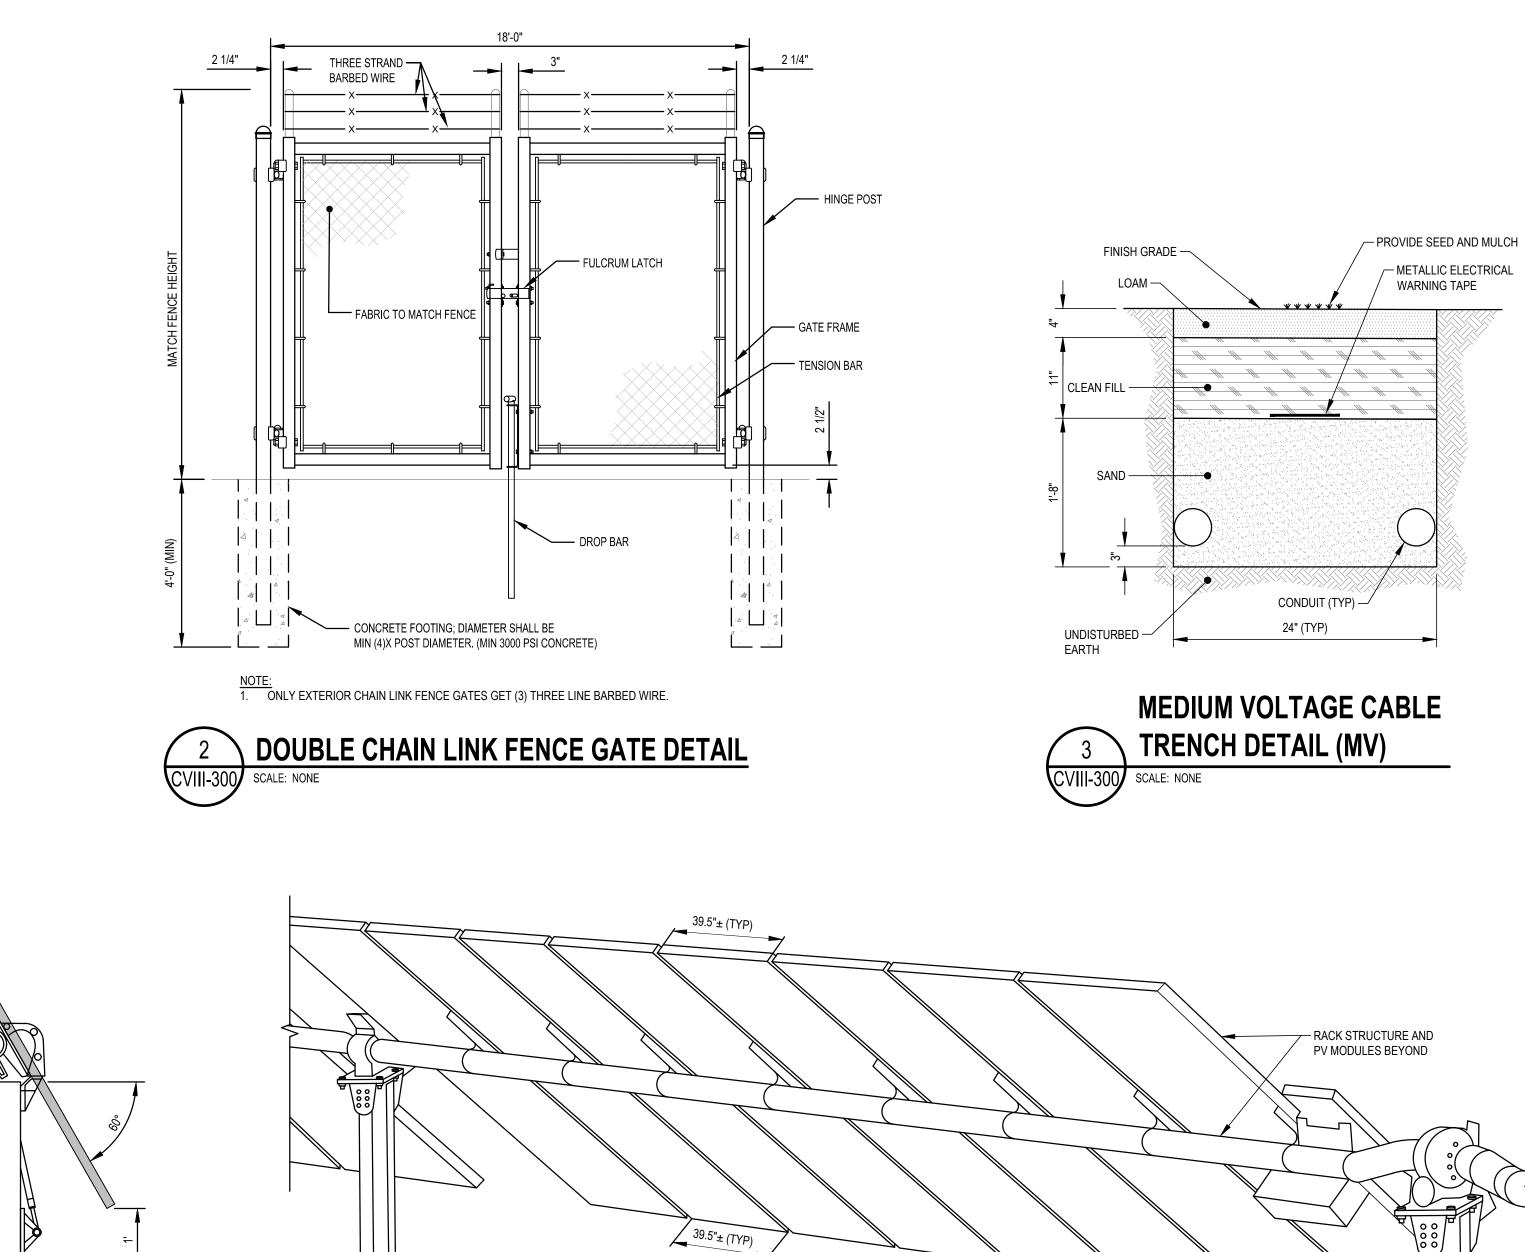

REAR VIEW

SIDE VIEW

NV6


1. RACK STRUCTURE AND PV MODULES SHOWN ARE FOR ILLUSTRATIVE PURPOSES ONLY. ACTUAL COMPONENTS MAY VARY.

2. DIMENSIONS SHOWN ARE BASED ON A 25-DEGREE (MINIMUM) SLANT ANGLE AND MAY VARY SLIGHTLY.


- 3. ARRAY ROW SPACING MUST ALWAYS BE EQUAL TO OR GREATER THAN ARRAY HORIZONTAL COVERAGE.
- 4. SUPPORTS VARY BASED ON SOIL CONDITIONS AND TYPICALLY VARY IN EMBEDMENT LEGNTHS FROM 4'-0" TO 7'-0".



NOTES:

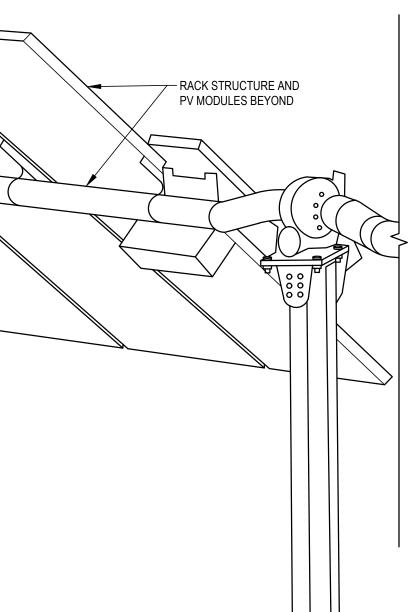

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,	8/17/2020	
No. Revision Project Name SSC CORTLANDVILLE III TOWN OF CORTLANDVILLE, NEW YORK STATE	Date	
ENGINEERS, ARCHITECTS, & SURVEYORS 860 Hooper Road Endwell, New York 13760 Tel: 607.231.6600 Fax: 607.231.6650 Email: mail@delta-eas.com www.delta-eas.com		
Seal Phase PLANNING E Project No. 2020.261 UNAUTHORIZED ALTERATION OF S A WOLATION OF THE NEW EDUCATION LAW, SECTION 720 2 Date 2020.07	1.001 F THIS DRAWING W YORK STATE DOR, SUBDIVISION	
Drawing Title	1.22	
DETAILS		
Drawing No.	0	

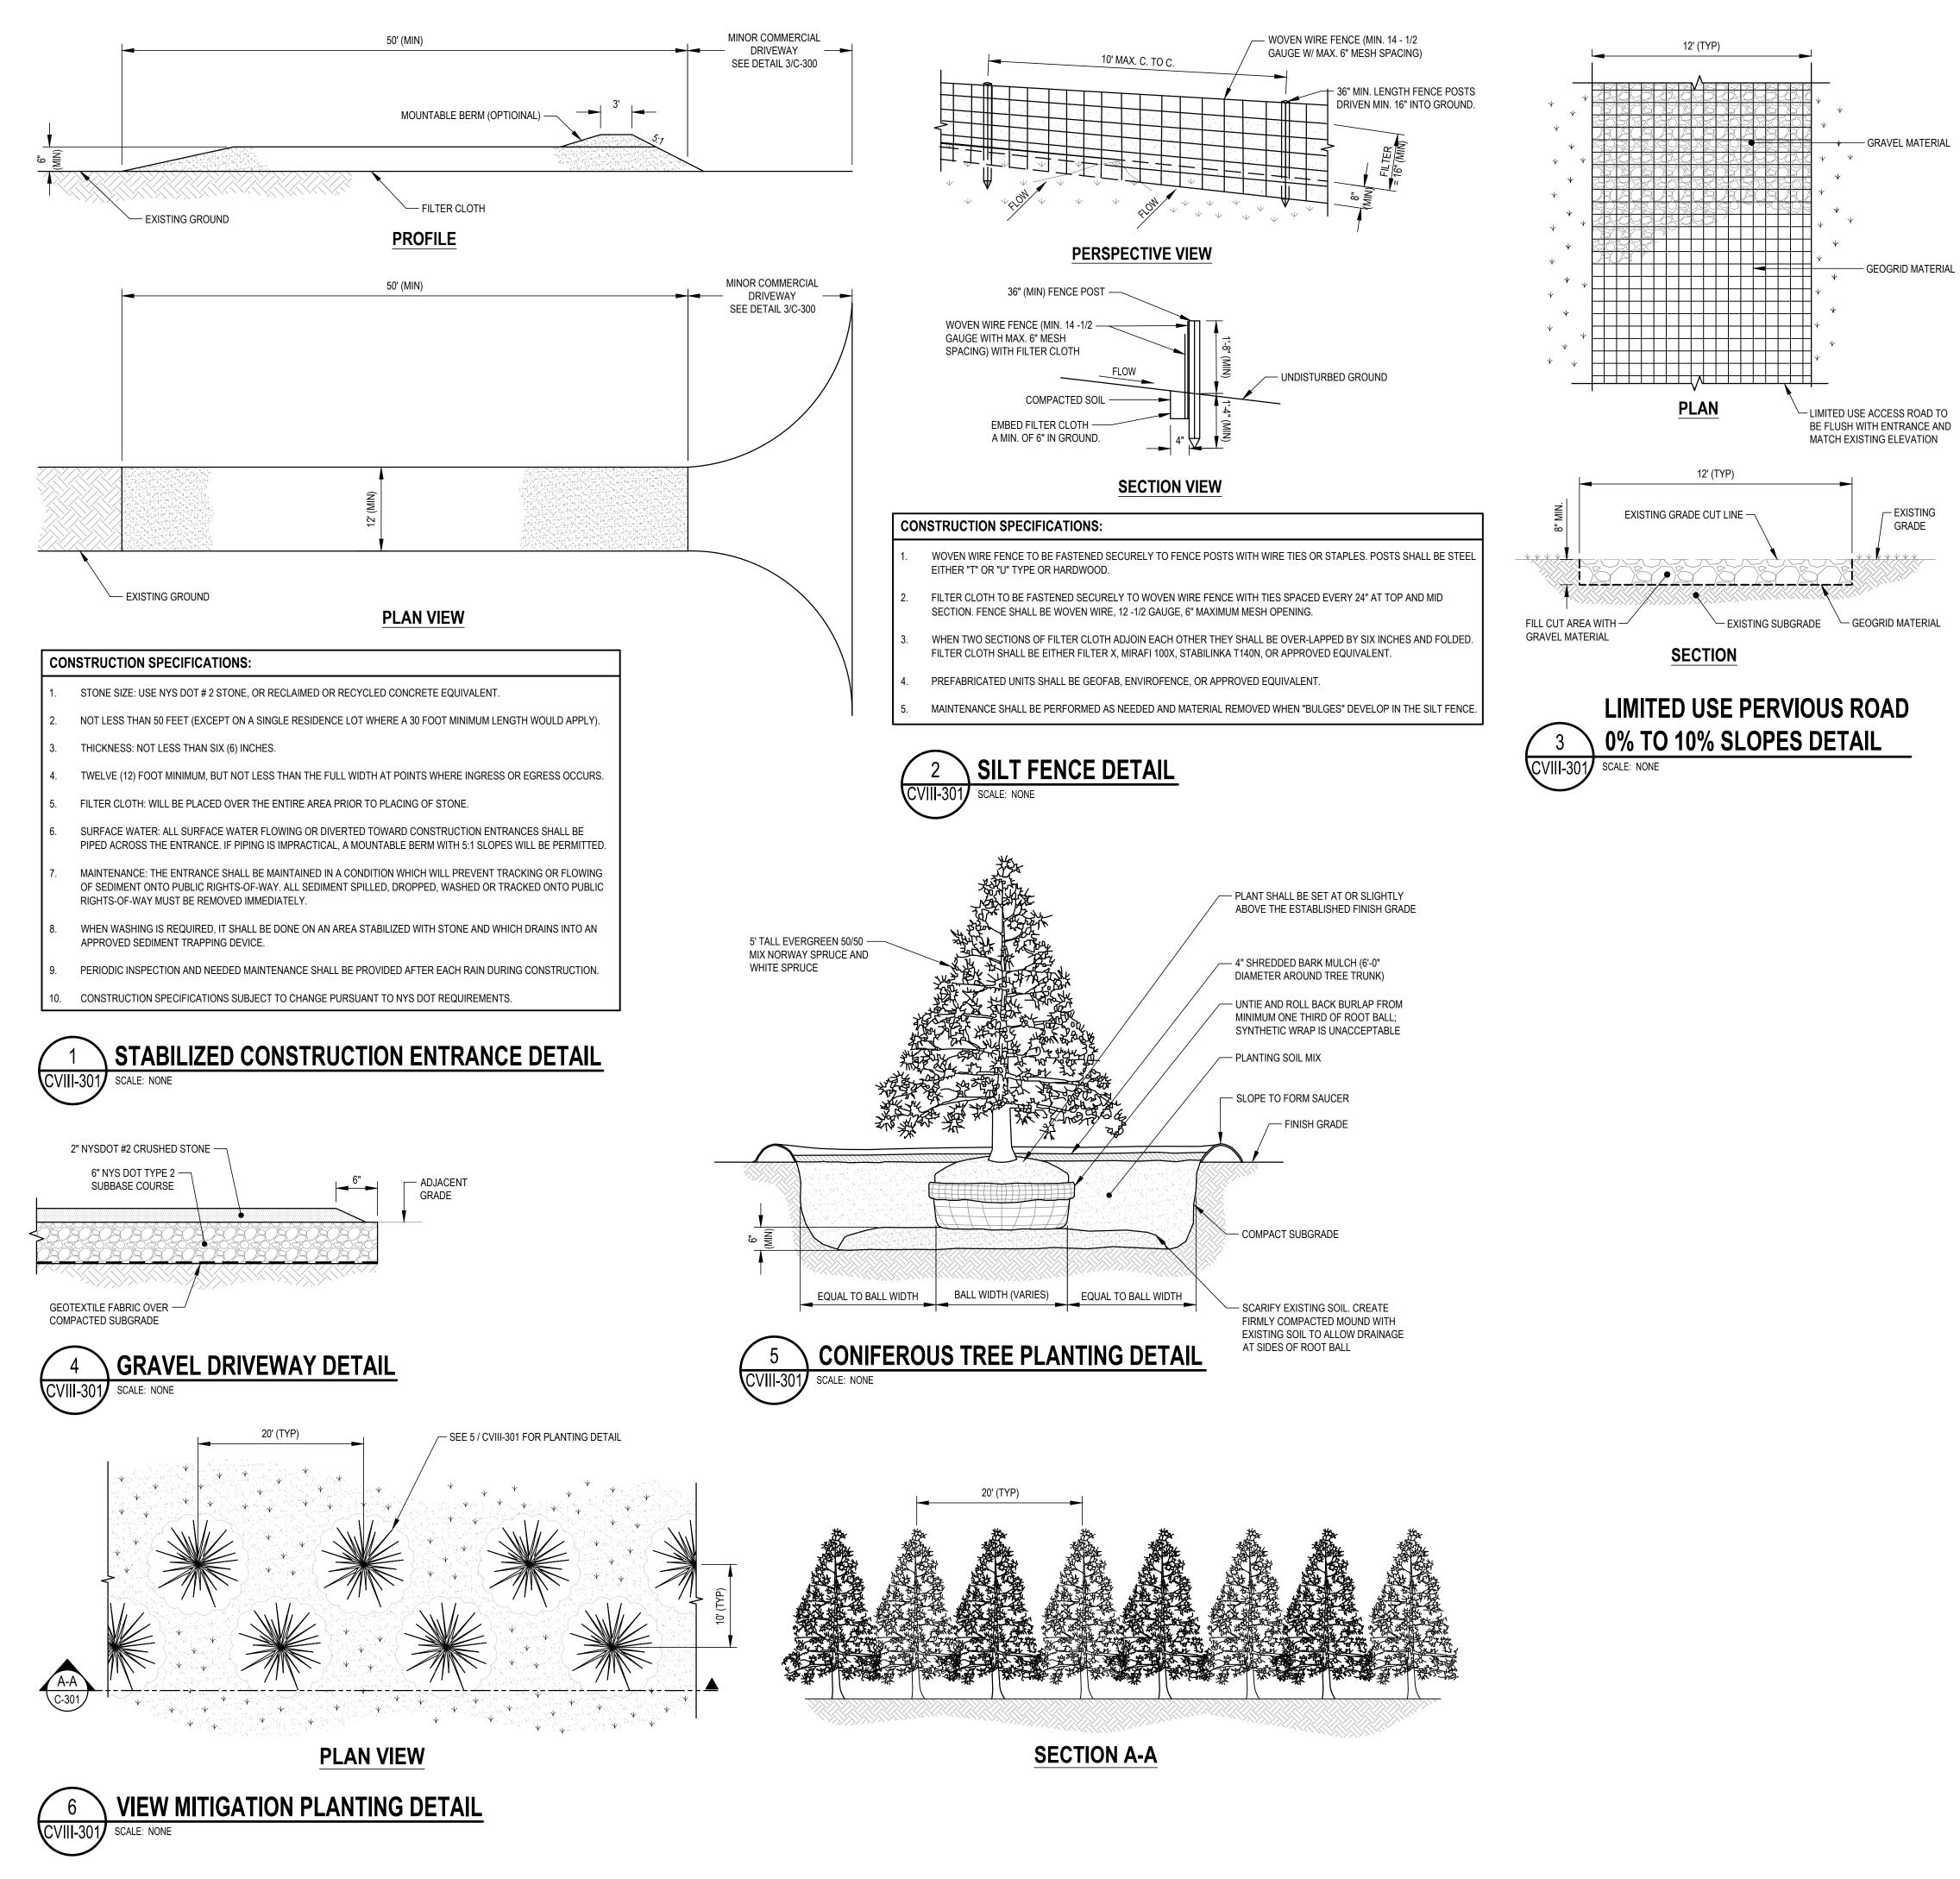

GENERAL NOTES:

- LIMITED USE PERVIOUS ACCESS ROAD IS LIMITED TO LOW IMPACT IRREGULAR MAINTENANCE ACCESS ASSOCIATED WITH RENEWABLE ENERGY PROJECTS IN NEW YORK STATE. REMOVE STUMPS, ROCKS AND DEBRIS AS NECESSARY. FILL VOIDS TO MATCH EXISTING
- NATIVE SOILS AND COMPACTION LEVEL. REMOVED TOPSOIL MAY BE SPREAD IN ADJACENT AREAS AS DIRECTED BY THE PROJECT ENGINEER. COMPACT TO THE DEGREE OF THE NATIVE INSITU SOIL. DO NOT PLACE IN AN
- AREA THAT IMPEDES STORMWATER DRAINAGE GRADE ROADWAY WHERE NECESSARY TO NATIVE SOIL AND DESIRED ELEVATION. MINOR GRADING FOR CROSS SLOPE CUT AND FILL MAY BE REQUIRED.
- REMOVE UNSUITABLE SOILS AS DIRECTED BY THE PROJECT ENGINEER. DO NOT PLACE IN AN AREA THAT IMPEDES STORMWATER DRAINAGE.
- TO ENSURE THAT SOIL IS NOT TRACKED ONTO THE LIMITED USE PERVIOUS ACCESS ROAD, IT SHALL NOT BE USED BY CONSTRUCTION VEHICLES TRANSPORTING SOIL, FILL MATERIAL, ETC. IF THE LIMITED USE PERVIOUS ACCESS ROAD IS COMPLETED DURING THE INITIAL PHASES OF CONSTRUCTION, A STANDARD NEW YORK STATE STABILIZED CONSTRUCTION ACCESS SHALL BE CONSTRUCTED AND UTILIZED TO REMOVE SEDIMENT FROM CONSTRUCTION VEHICLES AND EQUIPMENT PRIOR TO ENTERING THE LIMITED USE PERVIOUS ACCESS ROAD FROM ANY LOCATION ON OR OFFSITE. MAINTENANCE OF THE PERVIOUS ACCESS ROAD WILL BE
- REQUIRED IF SEDIMENT IS OBSERVED WITHIN THE CLEAN STONE. THE LIMITED USE PERVIOUS ACCESS ROAD SHALL NOT BE CONSTRUCTED OR USED UNTIL ALL AREAS WHERE UPGRADIENT SOIL DISTURBANCES (E.G CLEARING AND GRUBBING, GRADING, ETC) HAVE ACHIEVED FINAL STABILIZATION.

GEOGRID MATERIAL NOTES (0-10% SLOPES);

- GRAVEL FILL MATERIAL SHALL CONSIST OF 1-4" CLEAN, DURABLE SHARP-ANGLED CRUSHED STONE OF UNIFORM QUALITY, MEETING THE SPECIFICATIONS OF NYSDOT ITEM 703-02, SIZE DESIGNATION 3-5 OF TABLE 703-4. STONE MAY BE PLACED IN FRONT OF AND SPREAD WITH A TRACKED VEHICLE. GRAVEL SHALL NOT BE COMPACTED.
- GEOGRID SHALL BE MIRAFI BXG110 OR APPROVED EQUAL. GEOGRID SHALL BE DESIGNED BASED ON EXISTING SOIL CONDITIONS AND PROPOSED HAUL ROAD SLOPES.
- IF MORE THAN ONE ROLL WIDTH IS REQUIRED, ROLLS SHOULD OVERLAP A MINIMUM OF SIX INCHES.
- REFER TO MANUFACTURER'S SPECIFICATION FOR PROPER TYING AND CONNECTIONS.
- LIMITED USE PERVIOUS ACCESS ROAD SHALL BE TOP DRESSED AS REQUIRED WITH ONLY 1-4" CRUSHED STONE MEETING NYSDOT ITEM 703-02 SPECIFICATIONS

BASIS OF DESIGN: TENCATE MIRAFI BXG110; GEOGRIDS; 365 SOUTH HOLLAND DRIVE, PENDERGRASS, CA (800) 685-9990, OR (706) 693-2226: WWW.MIRAFI.COM

WOVEN GEOTEXTILE MATERIAL NOTES (POORLY DRAINED SOILS) :

SPECIFIED GEOTEXTILE WILL ONLY BE UTILIZED IN PLACID SOILS. PLACID SOILS CONSIST OF POORLY DRAINED SOILS COMPOSED OF FINELY TEXTURED PARTICLES AND ARE PRONOE TO RUTTING. PLACID SOILS ARE TYPICALLY PRESENT IN LOW-LYING AREAS WITH HYDROLOGIC SOLS GROUP (HSG) OF C OR D OR AS SPECIFIED FROM AN ENVIRONMENTAL SCIENTIST, SOIL SCIENTIST, OR GEOTECHNICAL DATA.

BASIS OF DESIGN: TENCATE MIRAFI RSI-SERIES WOVEN GEOSYNTHETICS; 365 SOUTH HOLLAND DRIVE, PENDERGRASS, GA; (800) 685-9990 OR (706) 693-2226; WWW.MIRAFI.COM

