THE GRACE BROWN HOUSE

FOR THE CORTLAND YWCA

1318 CARROLL STREET, CORTLAND, NEW YORK

HKK PROJECT #17005



LANDSCAPE ARCHITECT

KEPLINGER FREEMAN ASSOCIATES. LLC 6320 FLY ROAD, SUITE 201

EAST SYRACUSE, NY 13057-4224 PHONE: (316) 445-7980 FAX: (316) 445-7981

STRUCTURAL ENGINEER

ST. GERMAIN & AUPPERLE CONSULTING ENGINEERS, PLLC

CAMILLUS STATION, SUITE 100 CAMILLUS, NY 13031

ARCHITECT:

HOLMES • KING • KALLQUIST & ASSOCIATES, ARCHITECTS, LLP

575 NORTH SALINA STREET

MECHANICAL ENGINEER

ARGUS CONSULTING GROUP, LLC

247 WEST PAYEITE STREET SYRACUSE, NY 13202 PHONE (315) 475-6061

ABBREVIATIONS: SYMBOLS: ACCUSTIC CELING PAWE ACOUSTIC CELING TILE ADJACENT ADJACE ACP/ARC ACI/ARC ACI/AR EQUIL ESTITATE EQUIPTIENT EQUIPTIENT ELECTRIC WATER COOLER EXHAUST EXISTING EXTERIOR EXTERIOR EXTERIOR EXTERIOR FREE EXTINGUISHER FREE EXTINGUISHER FREE EXTINGUISHER FREE EXTINGUISHER FREE EXTENGUISHER FREE FROOFING FREE FROOFING FREE FREOOFING FREE FREATED FREENING FREENI REVISED/REVISION ROUNT R RET ROUGH ED CT PROPERTY OF THE TREE SHOWS THE THE THE SHOWS XX/XX/XX - REVISIONS SYMBO (xxx) WALL TYPE KEY CODE REVIEW: CONSTRUCTION TYPE: XXXX OCCUPANCY CLASSIFICATION: XXXX ALLOWABLE FIRE AREA: XXXX SQFT FLOOR AREA: BASEMENT: XXXX SQFT FIRST FLOOR: XXXX SQFT SECOND FLOOR: XXXX SQFT XXXX SQFT POPLILATION: XXX FIRST FLOOR: XXX SECOND FLOOR: XXX XXX

LIST OF DRAWINGS:

T1.1 TITLE SHEET

L1.0 SITE PREPARATION PLAN

L2.0 SITE GRADING, DRAINAGE AND UTILITY PLAN L3.0 SITE LAYOUT PLAN

L4.0 SITE PLANTING PLAN

L5.0 EROSION AND SEDIMENT CONTROL PLAN

L6.0 DETAILS

L7.0 PHOTOMETRICS PLAN

ARCHITECTURAL

A1.1 FIRST AND SECOND FLOOR PLAN THIRD FLOOR AND ROOF PLAN

EXTERIOR ELEVATIONS EXTERIOR ELEVATIONS

NATIONAL ENERGY CONSERVATION CO.

ISSUE DATE XX/XX/XXXX BID SET No.

PRELIMINARY NOT FOR CONSTRUCTION

REV No:	DATE:	DRAWN BY:	DESCRIPTION:
Ш			
		Ī	
	ALL DRAWAYS AND SPECIFICATIONS ARE THE PROPERTY OF THE ARCHITECT, AND SHALL BE USED OALY ON THE JOB DESIGNATED, COPYRIGHT (C)		
	THE CONTRACTOR SHALL VERIFY ALL DIMENSIONS AT THE SITE AND PROMETLY NOTIFY THE		
IL.	AT THE SITE AND PROMPTLY NOTIFY THE ARCHITECT IN WRITING OF ANY DISCREPANCIES.		

JOB NO: 17005 DATE: 08/17/2018 RAWN BY: KT

SCALE: NONE


HOLMES - KING - KALLOUIST
& Associates, Architects, LLP
575 North Salina Street, Synacus, NY 12208
Ph. (315) 476 - 8371 Fax. (315) 476 - 5420

BROWN HOUSE

GRACE B

THE

TITLE SHEET

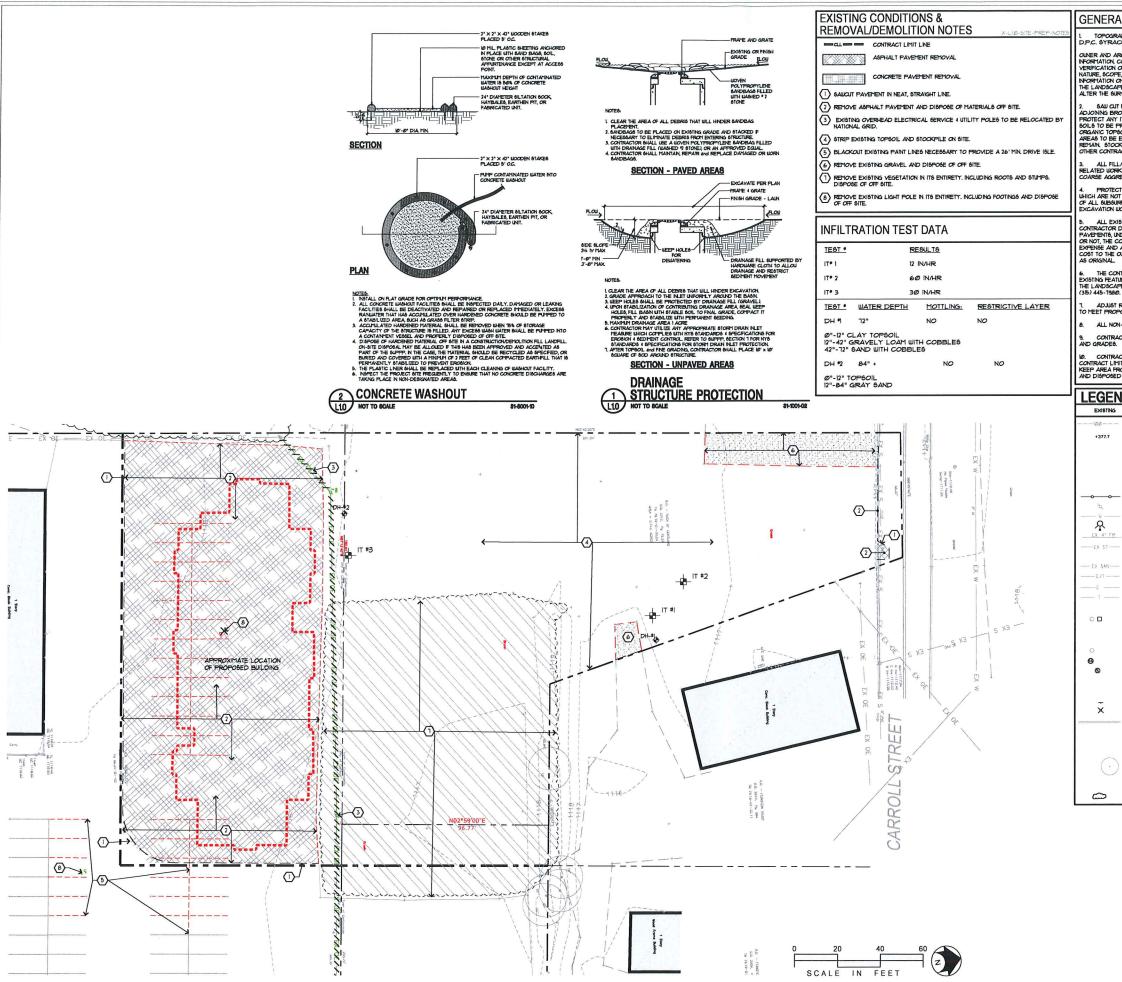

GENERAL NOTES

TOPOGRAPHIC AND BOUNDARY SURVEY PREPARED BY C.T. MALE ASSOCIATES D.P.C. SYRACUSE, NY, DATED AUGUST 14, 2017.

OUNER AND ARCHITECT DO NOT CONFIRM THE COMPLETENESS OR ACCURACY OF SUCH INFORMATION, CONTRACTOR IS RESPONSIBLE FOR THOROUGH EXAMINATION, AND VERRIFICATION OF ALL EXISTING SURFACE AND SUBSURFACE COMDITIONS AFFECTING THE NATURE, SCOPE, COMPLEXITY AND COST OF THE CONTRACT WORK, ADDITIONAL INFORMATION OF EXISTING CONDITIONS HAS BEEN ADDIED TO THE DRAWINGS BASED ON THE LANDSCAFE ARCHITECTS OBSERVATIONS BUT IS NOT INTERDED TO AND DOES NOT ALTER THE SURVEY INFORMATION, REFER TO SURVEY NOTES FOR ADDITIONAL INFORMATION.

2. SAIJI CUIT FOR PAYNIG REPOYAL S. EXTEND REPOYAL LINES TO INCLIDE ANY ADJONING BROKEN OR DETERIORATING PAYNIG. CAREFILLY REPOYE, STOCKPILE AND PROTECT ANY ITEMS NOTED FOR SAL YASE, ALL DEPIG LINION RIBBIELD, DERRIS AND EXCESSIONS TO BE FRICHENTY REPOYED FROM SITE. STREY AND STOCKPILE SUFFICIENT EXISTIN ORGANIC TOPOOLUBE FOR RESERVED AND AS REQUIRED ON DISTURBED DAY REGRADED AREAS TO BE ESTABLISHED AS LAUN AND FOR REPAIR OF DISTURBED DOWN DETERBAND.

D. ALL FILL/BACKFILL OF EXCAVATIONS AND VOIDS RESULTING FROM REMOVALS AND EACH DUTK UNDER PROPOSED OR REPLACEDIENT PAYING AREAS SHALL ONLY BE COARSE AGGREGATE FILL OR BUBBASE COURSE MATERIAL THOROUGHLY COMPACTED.

B. ALL EXISTING FEATURES SHALL REMAIN UNLESS OTHER LISE NOTED. IF THE COMPRACTION DAMAGES ANY OF THE EXISTING ON SHITE FACILITIES TO RETHAIN (TIRES, PAYETENIS), UNDERSEASON DILITIES, STEINURES, ETC.) MUETHER SHOUND ON THE PLAYS OR NOT, THE COMPRACTION SHALL REPAIR AND/OR REPLACE SUCH ITEMS AT HIS OIN DEPENDENT AND ASSISTED ALL RESPONSIBILITY FOR SUCH DAMAGE MITHOUT ANY ADDITIONAL COST TO THE OUNER REPLACED THE HATERIAL SHALL BE SATE QUALITY AND QUARTITY.

THE CONTRACTOR SHALL CONFIRM EXISTING GRADES AND LOCATIONS OF ALL EXISTING FEATURES WITHIN THE CONTRACT LIMIT LINE. THE CONTRACTOR SHALL CONTRACT THE LANDSCAPE ARCHITECT INTEDIATELY SHOULD ANY DISCREPANCIES BE FOUND AT (3B) 445-1920.

8. ALL NON-PAYED AREAS ARE TO BE LAWN UNLESS OTHERWISE NOTED.

CONTRACTOR SHALL BLEND NEW WORK SMOOTHLY AND EVENLY WITH EXISTING LINE AND GRADES.

IØ. CONTRACTOR SHALL BE RESPONSIBLE FOR LAWN MANTENANCE WITHIN THE CONTRACT LIMIT LINE. EXISTING LAWS SHALL BE MOUED AS MUCH AS PRACTICAL TO KEEP AREA FROM LOCKING MOSKITLY. ALL TRASH AND DEBRIS SHALL BE PICKED UP AND DISPOSED OF PROPERLY.

LEGEND EXISTING PROPOSED DESCRIPTION CONTOUR SPOT ELEVATION CT/CE CURB TAPERAND TC/BC TOP/BOTTOM OF CURE HPAP HIGH / LOW POINT TEST PIT Ф В-1 FORCE MAIN BANITARY LINE 67 STORM FIFE UNDERDRAN SANITARY PIPE OVER-EAD ELECTRIC UNDERGROUND ELECTRIC TELEPHONE FORCE MAIN MANHOL CLEAN OUT BANITARY MANHOLE AAPHALT PAVEMENT-PARKING CONCRETE PAVEMENT RAFFIC SIGN D-O LIGHT POLE (SEE ELECTRICAL PLANS FOR UTRING) CURB FLUSH (I' REVEAL UNLESS OTHERWISE NOTED. BILT FENCE ATHLETIC FIELD TURF or 800 \bigcirc_{∞} - AUNTITY FLANT KEY

STAMP


KEPLINGER FREEMAN ASSOCIATES LANDSCAPE ARCHITECTURE & LAND PLANNING 6320 FLY ICAO, SLITE TOP EAST SYLADJSE, NEW YORK 1305/ Provie: (315) 445-7780 HJX: (315) 445-7781

RZ Engineering, PLLC 6320 FLY ROAD, SLITE 109 EAST SYNACLISE, NY 13057 PH: 315.432.1089 FAX: 315.445.7981

PRELIMINARY NOT FOR CONSTRUCTION

REV No:	DATE:	BY:	DESCRIPTION:
1	9/19/17	MDL	CORTLANDVILLE PB SUBMISSION
2	7/31/18	MDL	BUILDING FOOTPRINT UPDATE
3	8/17/18	MOL	PLAYGROUND UPDATE

ALL DRAWINGS AND SPECIFICATIONS ARE THE PROPERTY OF THE ARCHITECT, AND SIALL BE USED ONLY ON THE JOB DESIGNATED, COPYRIGHT (1) THE CONTRACTOR SHALL VERIFY ALL DIMENSIONS AT THE SITE AND PROVINTLY NOTIFY THE ARCHITECT IN WRITING OF ANY DISCREPANCIES.

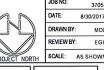

DRAWN BY: REVIEW BY: EGK SCALE: AS SHOWN


HOLMES • KING • KALLQUIST
& Associates, Architects, LLP
575 NORTH SALINA STREET: STRACUSE. NY 13208
PH: (315) 476-8371 FAX: (315) 476-5420
www.hkarchitects.com


GRACE BROWN HO FOR THE CORTLAND YWCA RROLL STREET, CORTLAND, NEW


THE


SITE PREPARATION PLAN

L1.0

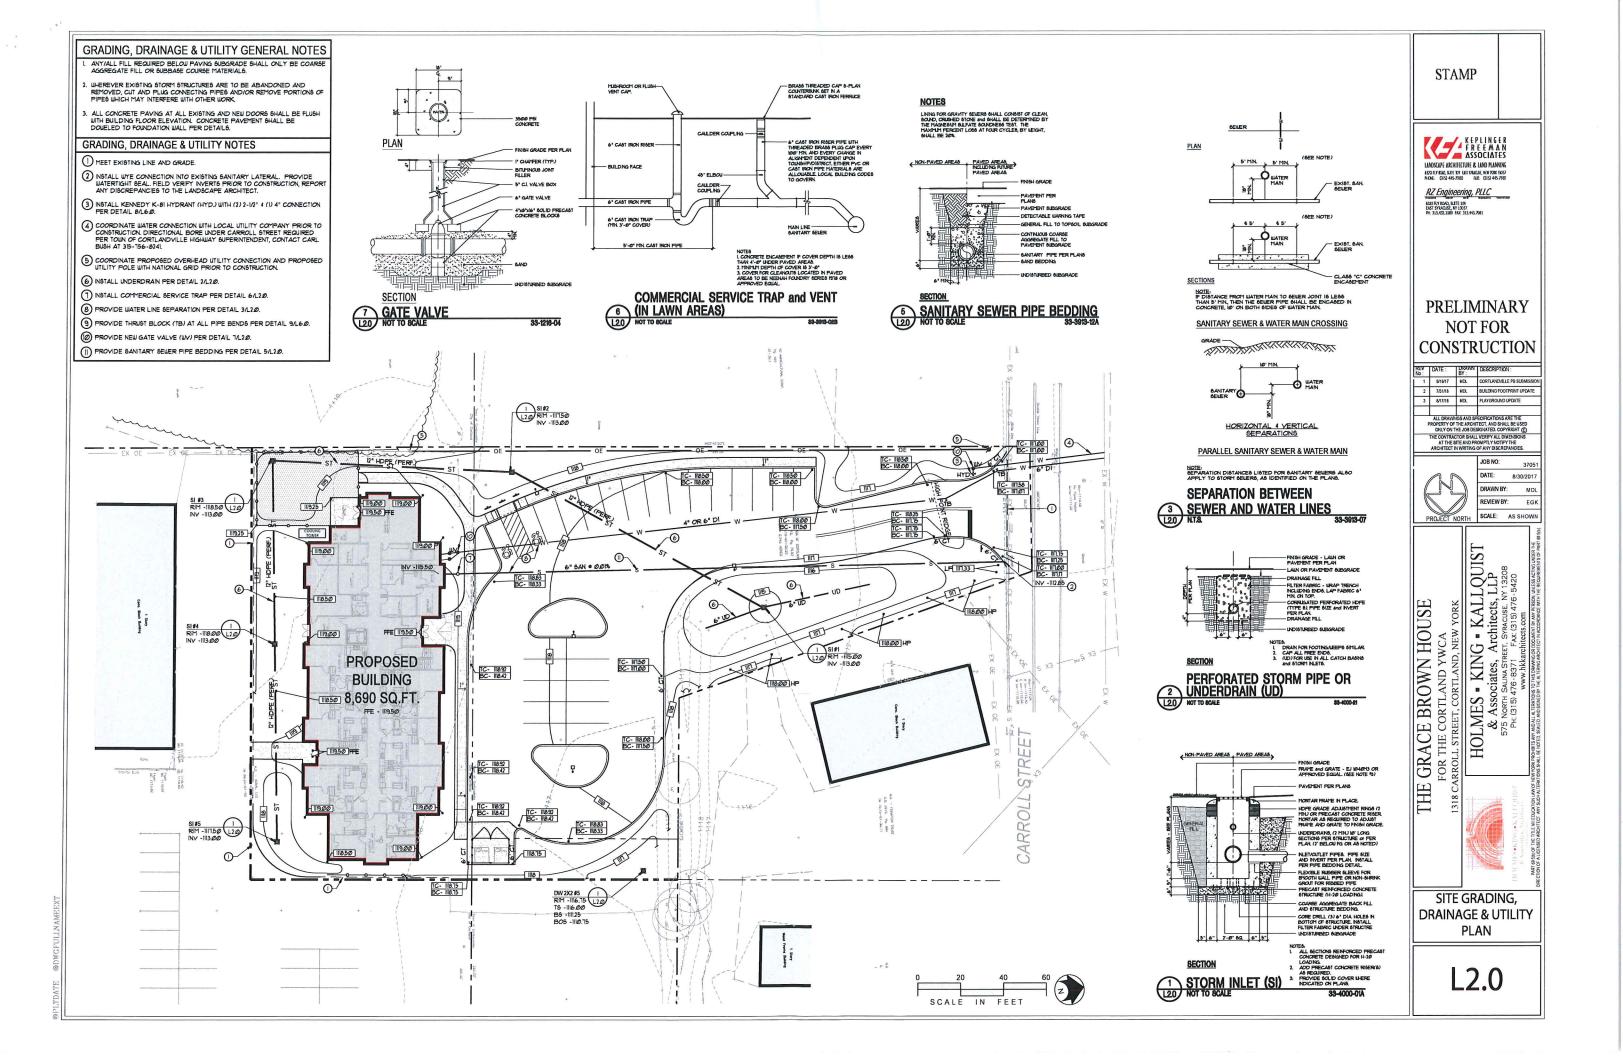

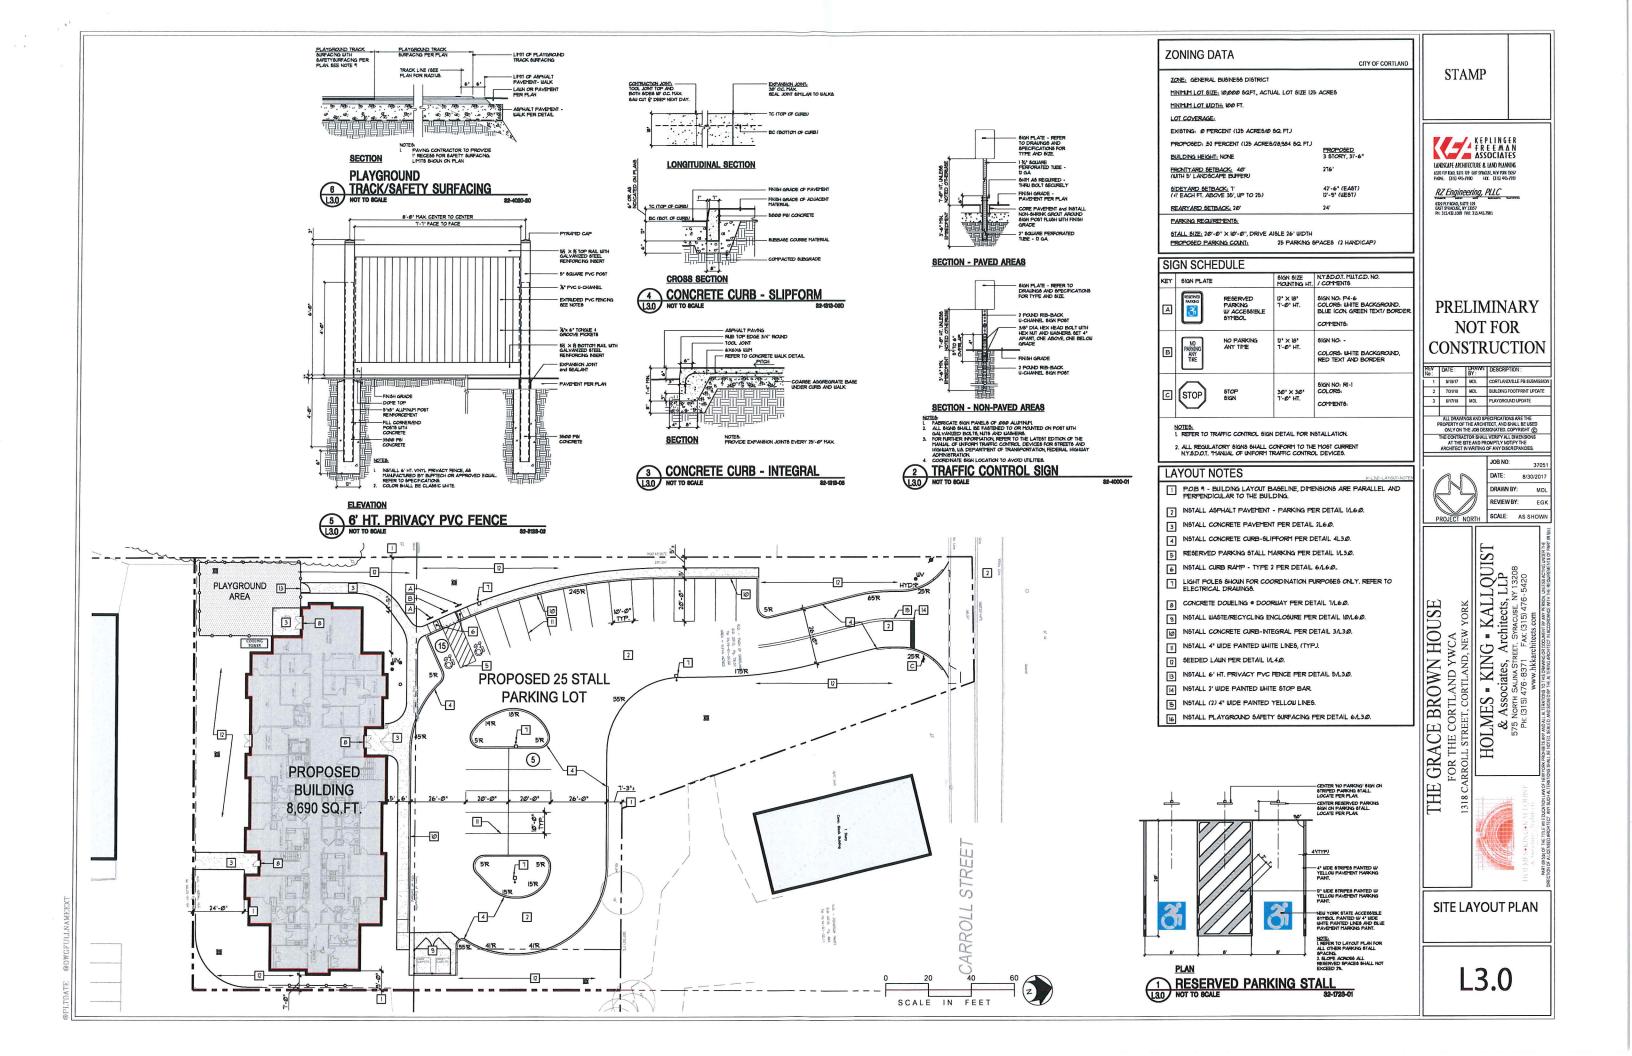

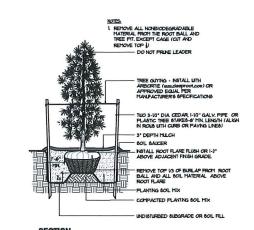

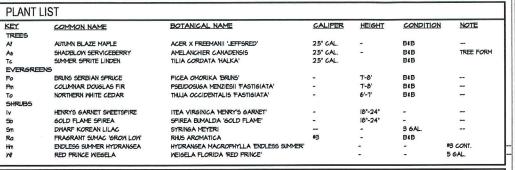


PLANT NOTES

3' DEPTH SHREDDED BARK MULCH WITH 18" OF SCREENED TOPSOIL


ALL PLANT BEDS TO HAVE SPADE OUT EDGES.

SECTION


4 EVERGREEN PLANTING
NOT TO SCALE

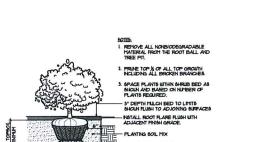

3 SHRUB PLANTING
(A0) NOT TO SCALE

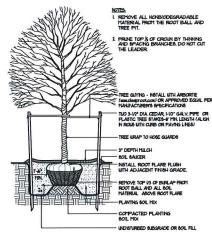

SECTION
TREE PLANTING
NOT TO SCALE

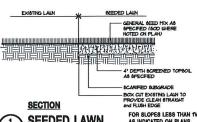

1 SEEDED LAWN
L4.0 NOT TO SCALE

FOR SLOPES LESS THAN 1VAT AS INDICATED ON PLANS

STAMP

K E P L I N G E R F R E E M A N ASSOCIATES LANDSCAPE ANCHITECTURE & LAND PLANNING 6320 FLY 1000, SLITE 107 (LST SPALOLSE, NEW YORK 1905) PHONE: C315) 445-7790 FLX: C315) 445-7791

RZ Engineering, PLLC 6320 FLY ROAD, SUITE 119 EAST SYNACLISE, NY 13057 PH: 315.432.1089 FAX: 315.445.7981

PRELIMINARY NOT FOR CONSTRUCTION

KEV No∶	DATE:	BY:	DESCRIPTION:
1	9/19/17	MDL	CORTLANDVILLE PB SUBMISS
2	7/31/18	MDL	BUILDING FOOTPRINT UPDAT
3	8/17/18	MDL	PLAYGROUND UPDATE




GRACE BROWN HOUSE FOR THE CORTLAND YWCA RROLL STREET, CORTLAND, NEW YORK

8/30/2017 DRAWN BY: MD REVIEW BY: SCALE: AS SHOWN

HOLMES • KING • KALLQUIST & Associates, Architects, LLP 575 NORTH SALINA STREET, SYRACUSE, NY 13208 PH. (315) 476-8371 FAX (315) 476-5420

SITE PLANTING PLAN

L4.0

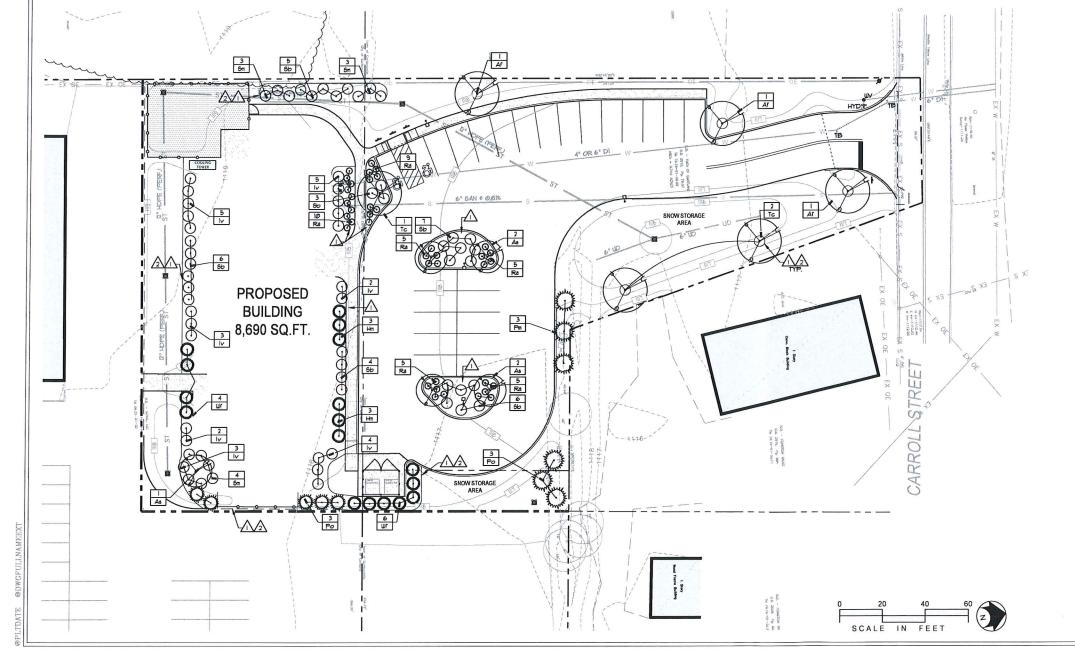

EROSION CONTROL NOTES

and EROSION CONTROL SEQUENCING

EROSION AND SEDIMENT CONTROL NOTES:

I. PRIOR TO THE START OF CONSTRUCTION AND WITH. ALL DISTURBED AREAS ARE
STABILIZED, ALL EROSION AND BEDIFIENT CONTROL PRESSURES, AS SHOUN ON THE SITE
PLAN, SHALL BE INSTALLED AND MAINTAINED BY THE CONTRACTOR, AND SHALL BE IN
ACCORDANCE WITH THE LATEST EDITION OF THE NEW YORK STATE GUIDELINES FOR URBAN
EROSION AND SEDIMENTATION CONTROL AND THE SUPPLY PREPARED FOR THE PROJECT,
PRIOR TO THE CONTROLADY CONTROL AND

2. BARE SOILS SHALL BE SEEDED WITHIN IA DAYS OF EXPOSURE, INLESS CONSTRUCTION WILL BEGIN WITHIN 31 DAYS, AS SECTIONS ARE COMPLETED, OR IF CONSTRUCTION ON AN AREA IS SUSPENDED, THE AREA SHALL BE SEEDED INTEDIATELY.

3. BITE PREPARATION SHALL INCLUDE:

A. SEEDBED PREPARATION - SCARETY F COMPACTED, REMOVE DEBRIS AND COSTACLES SUCH AS ROOTS OR STUMPS.

B. SOIL ATENDMENTS

L. LIME TO PH 6.00 LBS OF 5-10-10 OR EQUIVALENT PER ACRE
(14 LBS/100 BQ FT).

SEED MIXINES

L. TEMPORATY SEEDINGS

8. RYEGRASS (ANNUAL OR PERENNIAL) • 30 LBS/ACRE
(0.1 LBS/1000 BQ FT).

b. CERTIFIED *ARROSTIOCK WINTER RYE (CEREAL RYE) • 100 LBS/ACRE

(07) LB5/6009 5Q F1.0

CERTEIED 'ABCOSTOCK' WHIER RYE (CEREAL RYE) ● 1600 LB5/ACRE
(75 LB6/6000 5Q FT).

PER"ALENT SEEDING

8. ROUGH OR OCCASIONALLY MOUED AREAS:

SILT FENCE

SEDIMENT TRAP . CB/INLET CONSTRUCTION ENTRANCE

SWPPP LEGEND

O

LBS/ACRE EMPIRE BIRDSFOOT TREFOIL OR COMMON WHITE CLOVER PLUS 020 02 TALL FESCUE PLUS REDTOP RYEGRASS (PERENNIAL)

ADD NOCULANT IMMEDIATELY PRIOR TO SEEDING

D. METHOD OF SEEDING:
BROADCASTING, DRILLING WITH CULTIPACK TYPE SEEDER OR
HYDROSEEDING ARE ACCEPTABLE.

4. DISTURBED AREAS SHALL BE SEEDED AS NOTED ABOVE AND MULCHED WITH CLEAN STRAW AS OUTLINED IN THE NEW YORK STATE GUIDELINES FOR URBAN EROSION AND SEDIMENTATION CONTROL

b. THE CONTRACTOR SHALL BE RESPONSIBLE FOR KEEPING THE STREET PAYEMENT AREAS CLEAN OF DIRT AND DEEPING.

6. ACCESS TO DISTURBED AREAS SHALL BE LIMITED TO THE AREAS SHOWN ON THE FLAN. THE CONTRACTOR SHALL INSTALL THE STABILIZED CONSTRUCTION ENTRANCE AT THE LOCATIONS SHOUN OF THE FLAN AND ANY OTHER LOCATIONS THE CONTRACTOR INTENDS TO ENTER THE SITE FROM THE ADJACENT ROADULAYS.

ANY EXISTING DRAINAGE FACILITIES DISPUPTED BY CONSTRUCTION OR IMPACTED
BY INSTALLATION OF EROSION CONTROL MEASURES SHALL BE REPLACED TO MATCH
EXISTING CONDITIONS OR BETTER

8. SEE DRAWING L-I FOR LEGEND.

TEMPORARY EROSION AND SEDIMENTATION CONTROL FACILITIES - AS SEDIMENT ACCUPILATES TO \$1 THE DEPTH OF THE FOREBAY OR BASIN, SEDIMENT SHALL BE REMOYED AS OUTLINED IN THE MYS GUIDELINES FOR URBAN EROSION AND SEDIMENT CONTROL.

IO. DIRECT ACCESS SHALL BE PROVIDED TO ALL BASIN AREAS FOR MAINTENANCE AND REHABILITATION.

IL ALL DESIGN AND MAINTENANCE MEASURES OUTLINED IN THE SUPPLY PREPARED FOR THIS PROJECT SHALL BE IMPLEMENTED AND CARRIED OUT BY THE PARTIES DEEMED RESPONSIBLE FOR THOSE DUTIES.

17. THE PERMITTEE I ITS SUBCONTRACTORS ARE RESPONSIBLE FOR MEANS I METHODS OF EROSION CONTROL FACILITIES DURING CONSTRUCTION. IT SHOULD DE NOTED THAT FACILITIES OF IMPLIED PRIMITAL PARTICLATION OF THIS DRAIMING ARE CONSIDERED MINIMAL IN ADDITIONAL EROSIONS OF THE REQUIRED AS CONSTRUCTION PROSPESSES. THE PERMITTEE I ITS SUBCONTRACTORS ARE RESPONSIBLE FOR ANY ADDITIONAL MEASURES DESPED NECESSARY BY THE LANDSCAPE ARCHITECT, SUPPEP INSPECTOR

IS, PROVIDE EROBION CONTROL MEASURES AS NOTED ON THE PLANS AND AS OTHERWISE REQUIRED TO PREVENT EROSION AND SEDIMENTATION ONTO ADJOINNS PROPERTY, STREETS, WATERLINKS, AND ON DITE IMPROVEMENTS BETYON THE LIMITED OF UNION COMPLY WITH THE LIMITED ISSUE OF NEW YORK CUIDELINES FOR WREAN EROSION, AND SEDIMENT CONTROL! AND THE HYSOEC'S "REDUCING THE IMPACTS OF STORTMATER RINGET FROM NEW DEVELOPMENT."

14. MAINTENANCE - THE CONTRACTOR SHALL INSPECT ALL DRAINAGE STRUCTURES AND ERBOICN CONTROLS ON A MEEKLY BABIS AND AFFER ALL STORMS (I RAINFALL OR GREATER) INCLUDING BUT NOT LIMITED TO THE FOLLOWING. REPLACING DAMAGED OR SILTED IN ERBOICN CONTROLS, CLEANING OUT STRUCTURES, AND STABILIZING ERODED OR MASHED OUT SLOFED AREAS.

B. CONTRACTOR SHALL MANTAN EROSION CONTROL MEASURES UNTIL CONSTRUCTION IS COMPLETE, LAUNS HAVE BECOME ESTABLISHED AND ALL SOURCES OF EROSION HAVE BEEN PERMANENTLY STABILIZED.

IS. CONTRACTOR SHALL PROVIDE DUST CONTROL IN ACCORDANCE WITH THE LATEST ISSUE OF "NEW YORK GUIDELINES FOR URBAN EROSION AND SEDIMENT CONTROL."

EROSION CONTROL and CONSTRUCTION SEQUENCE PHASE 1 - SITE and PREPARATION

L PRIOR TO SITE DISTURBANCE, CONSTRUCT 18'X 50" STABILIZED CONSTRUCTION ENTRANCES OF 6" MINIMM STONE ASSREGATE UNDERLAIN WITH FILTER FABRIC AT PROPOSED SITE ENTRANCE LOCATIONS AS SHOWN ON THE DRAWING.

2. SILT FENCE - INSTALL PERIMETER SILT FENCE AS SHOUN ON PLAN PRIOR TO EARTHUORS, SILT FENCE SHALL BE UTILIZED ONLY AS A TEMPORARY MEASURE, DISTURBED AREAS SHALL BE SEEDED IMMEDIATELY FOLLOUNS THE COMPLETION OF ANY EARTHWORS, PHASE.

3. CLEARING and GRUBBING - REMOVE ALL TREES, STUMPS AND BRUSH PRIOR TO EARTHWORK

4. STRIP AND STOCKPILE TOPSOIL IN AREA SHOWN ON PLAN AND / OR AGREED UPON LOCATION WITH OWNER ENCLOSE TOPSOIL AREAS WITH SILT FENCE.

5. GRADE WATER QUALITY / DETENTION BASIN INCLUDING OUTLET PIPES 4 STRUCTURES AS SHOUN ON THE DRAWINGS. PROVIDE RIP RAP STONE PROTECTION AFRONS AT OUTLET LOCATIONS AS SHOUN ON THE DRAWING FINE GRADE, SEED AND MILCH WITHIN SEVEN (17) DAYS OF DISTURBANCE. MAINTAIN ALL DISTURBED SOIL AREAS AND DRAINAGE FACILITIES WITLL COMPLETELY STABILIZED AND VEGETATION IS ACHIEVED.

6. PROVIDE DRAINAGE STRUCTURES AND PIPING, INCLUDING DRAINAGE NLET PROTECTION AS SHOWN ON THE DRAWING.

1. PROVIDE DRAINAGE CHANNELS AND INSTALL EROSION CONTROL MEASURES WITHIN DRAINAGEWAYS.

8. MAKE ALL CONNECTIONS TO EXISTING STORM SYSTEM FACILITIES.

9. COORDINATE GAS, ELECTRIC 1 UTILITIES (PHONE, CABLE, ETC.) INSTALLATION WITH APPROPRIATE AGENCIES, CONTRACTOR TO TEMPORARY SEED ALL AREAS DISTURBED BY UTILITY CONTRACTORS 1 OTHERS WITHIN 1 DAYS.

IØ. EXCAVATE, FILL GRADED AREAS AS SHOWN ON THE DRAWINGS, FINE GRADE, SEED AND MULCH ALL DISTURBED AREAS WITHIN SEVEN (1) DAYS OF DISTURBANCE, AREAS TO RECEIVE ASPHALT PAVENENT SHOULD BE PAVED WITH AT LEAST THE ASPHALT BINDER COURSE WITHIN SEVEN (1) DAYS OF PLACEMENT OF THE SUBBASE COURSE.

II. REMOVE TEMPORARY CONSTRUCTION ENTRANCE AFTER ASPHALT BINDER COURSE IS PLACED.

12. MAINTAIN ALL DISTURBED SOIL AREAS AND DRAINAGE FACILITIES UNTIL AREAS ARE COMPLETELY STABILIZED AND VEGETATION IS ACHIEVED.

3. CLEAN WATER QUALITY / DETENTION BASIN AFTER ALL UPSTREAM CONTRIBUTORY DRAINAGE AREAS ARE COMPLETELY STABILIZED AND VEGETATION IS ACHIEVED.

I4, REMOVE TEMPORARY SILT FENCING, TRANSVERSE DITCH CONTROL MEASURES AND ROCK CHECK DAMS AFTER SITE IS COMPLETELY STABILIZED AND VEGETATION IS ACHIEVED, PROVIDE RIP RAP WITHIN DIVERSION DRAINAGE CHANNEL ALONG PROPERTY LINE AS SHOUN ON THE

FINAL CLEAN UP

REMOVE AND/OR MAINTAIN STOCKPILE AREAS.

, REMOVE EROSION CONTROL MEASURES FROM STABILIZED AREAS.

3, FINAL CLEAN UP - REMOVE EROSION CONTROL MEASURES AND CLEAN OUT ALL DRAINAGE STRICTURES AND PIFES AFTER LAIN 16 UED ESTABLISHED, OUNER RESPOSIBLE FOR MAINTAINING SITE UPON PROJECT

5. SUBMIT NOTICE OF TERMINATION UPON FULL STABILIZATION OF SITE.

STAMP

KEPLINGER FREEMAN ASSOCIATES LANDSCAPE ARCHITECTURE & LAND PLANNING 6320 FLY NOAD, SUITE NOT EAST DYNAME, NEW YORK TROSS FRONE: (315) 445-7780 FLX: (315) 445-7781

RZ Engineering, PLLC 6320 FLY ROAD, SUITE 109 EAST SYRACLISE, NY 13057 PH: 315.432.1089 FAX: 315.445.7981

PRELIMINARY NOT FOR CONSTRUCTION

REV No:	DATE:	BY:	DESCRIPTION:
1	9/13/17	MDL	CORTLANDVILLE PB SUBMISSION
2	7/31/18	MDL	BUILDING FOOTPRINT UPDATE
3	8/17/18	MDL	PLAYGROUND UPDATE

ALL DRAWINGS AND SPECHICATIONS ARE THE
PROPERTY OF THE ARCHITECT, AND SHALL BE USED
ONLY ON THE JOB DESIGNATED, COPYRIGHT (©)
THE CONTRACTOR SHALL VERIFY ALL DIMENSIONS
AT THE SITE AND PROMPTLY NOTIFY THE
ARCHITECT AND PROMPTLY NOTIFY THE



HOUSE

GRACE BROWN HOU FOR THE CORTLAND YWCA ARROLL STREET, CORTLAND, NEW Y


THE

8/30/2017 DRAWN BY: REVIEW BY: EGK SCALE: AS SHOWN

J = KALLQUIST Architects, LLP 1. Syracuse. NY 13208 FAX: (315) 476-5420

HOLMES = KING = & Associates, Arc 575 NORTH SALINA STREET. SPH. (315) 476 - 8371 FAX


CONSTRUCTION ENTRANCE (MUDRACK)

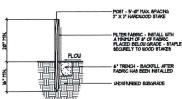


SILT FENCE (SF)


L5.0

EROSION & SEDIMENT CONTROL PLAN

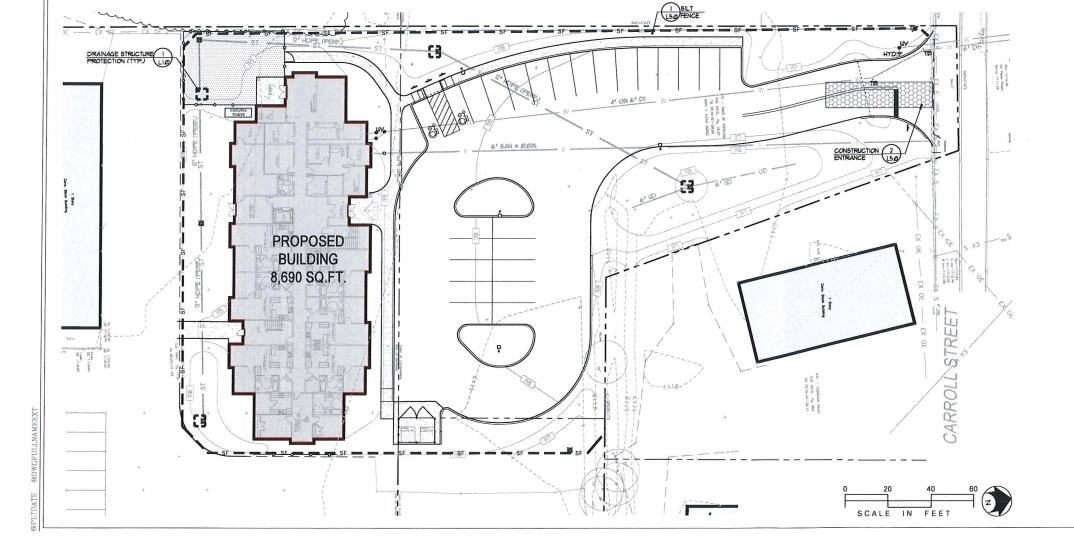

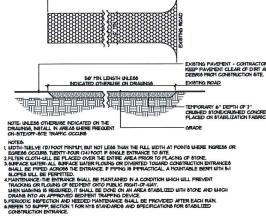

SECTION

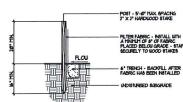

NOTES.

LOVING UNE FRICE TO BE FASTEDED SECURELY TO FENCE POSTS UTH UNE
TIES OR GIÁPELS.

F. RETRE CLOTH OFF AND THE SECURELY TO MOVEN UNE FRICE UTH TIES

RETRE LOVING OFF AND THE SECURELY TO MOVEN UNE FRICE UTH TIES

S. MEN THO SECUREN OF RUTER CLOTH AND EACH OTHER THEY SHALL BE
OVERLAFED BY SN (6) NOESS AND FALDED.

A FANTINHAVE SHALL BE FERFORED AN DEEDED AND HATBRIAL REPOYNED

HOWER SHALL BY DEVELOP IN THE SILT FRICE THORN SHALL BE MARRIEDTED

HOWING THE STATE OF THE SILT FRICE THORN SHALL BE MARRIEDTED

HOWER THE SILT HATBRIAL SHALL BE WEDT FOR CONSTRUCTION OF THE SILT.


CE:
POSTS: STEEL EITHER "T" OR "U" TYPE OR 2" HARDWOOD
FENCE: WOMEN WIRE H-VI GA, 6" MAX MEGH OFENNS.
FILTER CLOTH: FILTER X, MRAFI 1800X, STABULNKA THAIN OR APPROVED


EQUIL.


FREFABRICATED UNTI GEOFAB, ENVIROPENCE, OR APPROVED EQUIL.

FREFA TO NTS STANDARDS I SPECIFICATIONS FOR EROSION AND SEDIMENT
CONTROLS FOR ADDITIONAL GUIDANCE.

SECTION

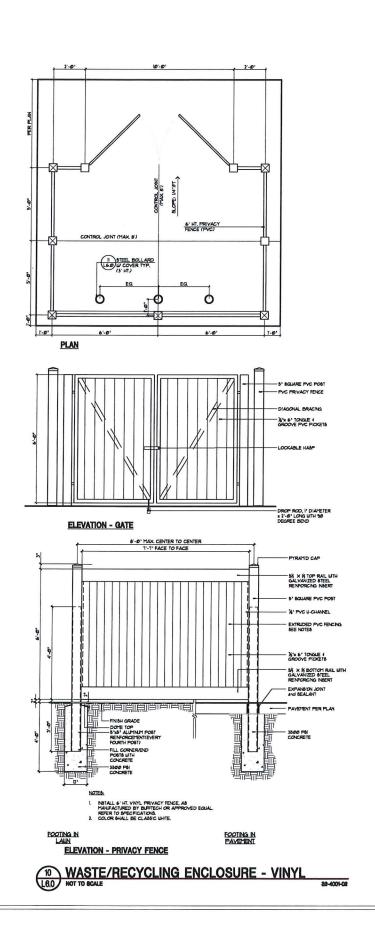


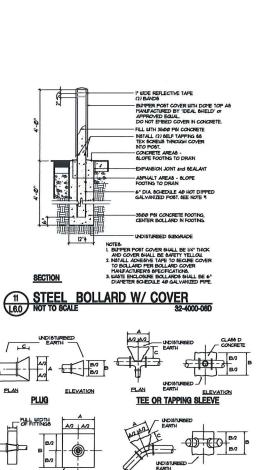

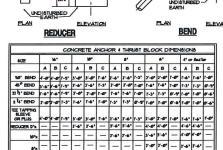



THRUST BLOCK NOTES:



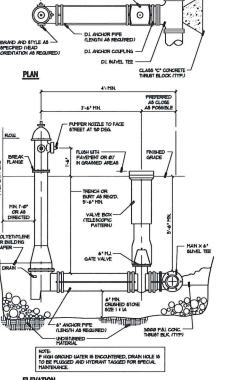





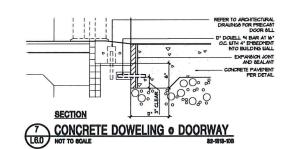

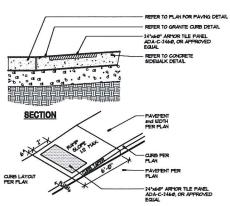




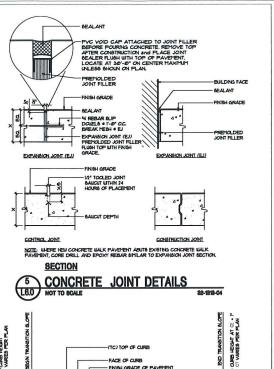


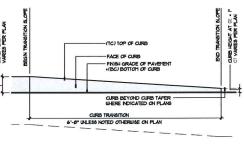




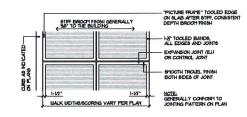



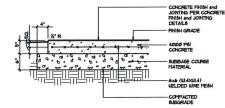



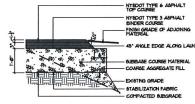

SECTION ASPHALT PAVEMENT - PARKING
NOT TO SCALE SE-1279**STAMP**

KEPLINGER FREEMAN ASSOCIATES LANDSCAPE ARCHITECTURE & LAND PLANNING 4320 RY IGAD, SLIFE TOP GLIS SYMOLEF, NEV YORK TROST PRONE: (315) 445-7780 FAX: (315) 445-7781

RZ Engineering, PLLC 6320 R.Y ROAD, SLETE 109 EAST SYRACLISE, NY 13057 PH: 315.432.1089 FAX: 315.445.7981

PRELIMINARY NOT FOR CONSTRUCTION

ŒV Vo∶	DATE:	BY:	DESCRIPTION:
1	9/19/17	MDL	CORTLANDVILLE PB SUBMISSION
2	7/31/18	MDL	BUILDING FOOTPRINT UPDATE
3	8/17/18	MDL	PLAYGROUND UPDATE
3	PROPERTY O	THE ARCHI	PECIFICATIONS ARE THE TECT, AND SHALL BE USED SIGNATED. COPYRIGHT ©



SCALE: AS SHOWN

HOLMES • KING • KALLQUIST & Associates, Architects, LLP 575 North Salina Street, Spracuse, NY 13208 PH. (315) 476-8971 FAX. (315) 476-5420

HOUSE

THE (

E GRACE BROWN FOR THE CORTLAND YW

DETAILS

L6.0

