



Also Doing Business As (DBA):



TRANSMITTAL

To: Town of Cortlandville Planning & Zoning Project: Cortland-Virgil Solar
The Raymond G. Thorpe Municipal Building
 3577 Terrace Road
Cortland, New York 13045 Project #: 2850.24418.6
 Attn: Mr. Bruce Weber Date: February 12, 2019

Quantity	Date	Description
5	12/18/18	Original Submittal Package with 11x17 drawings
2	2/12/19	Full Size Submittal drawings
10	2/12/19	11x17 Size submittal drawings

This is transmitted as checked below:

- | | | |
|--|---|---|
| <input checked="" type="checkbox"/> For approval | <input type="checkbox"/> No Exception Taken | <input type="checkbox"/> Reviewed |
| <input type="checkbox"/> For your use | <input type="checkbox"/> Furnish as Corrected | <input type="checkbox"/> Rejected |
| <input type="checkbox"/> For review & comment | <input type="checkbox"/> Revise and Resubmit | <input type="checkbox"/> Submit Specified Item |
| <input type="checkbox"/> As requested | <input type="checkbox"/> For immediate action | <input type="checkbox"/> Prints returned after loan to us |

Remarks:

As discussed, please find the above listed documents for sketch plan consideration at the February 12, 2019 meeting.

Thank you.

Copy To: file Signed: Paul T. Woodward, Senior Designer

SOLAR ARRAY PLAN

CORTLAND-VIRGIL ROAD SOLAR

301 SOUTH CORTLAND VIRGIL ROAD

TOWN OF CORTLANDVILLE

COUNTY OF CORTLAND



STATE OF NEW YORK

APPLICANT/DEVELOPER:

CORTLAND-VIRGIL ROAD SOLAR, LLC
 55 5TH AVENUE, FLOOR 13
 NEW YORK, NEW YORK 10003

INDEX OF DRAWINGS

<u>SHEET</u>	<u>TITLE</u>
C010	EXISTING SITE CONDITIONS
C100	SITE PLAN
C110	EROSION AND SEDIMENT CONTROL PLAN
C200	FARM LAND SOILS AND DETAILS
C210	DETAILS

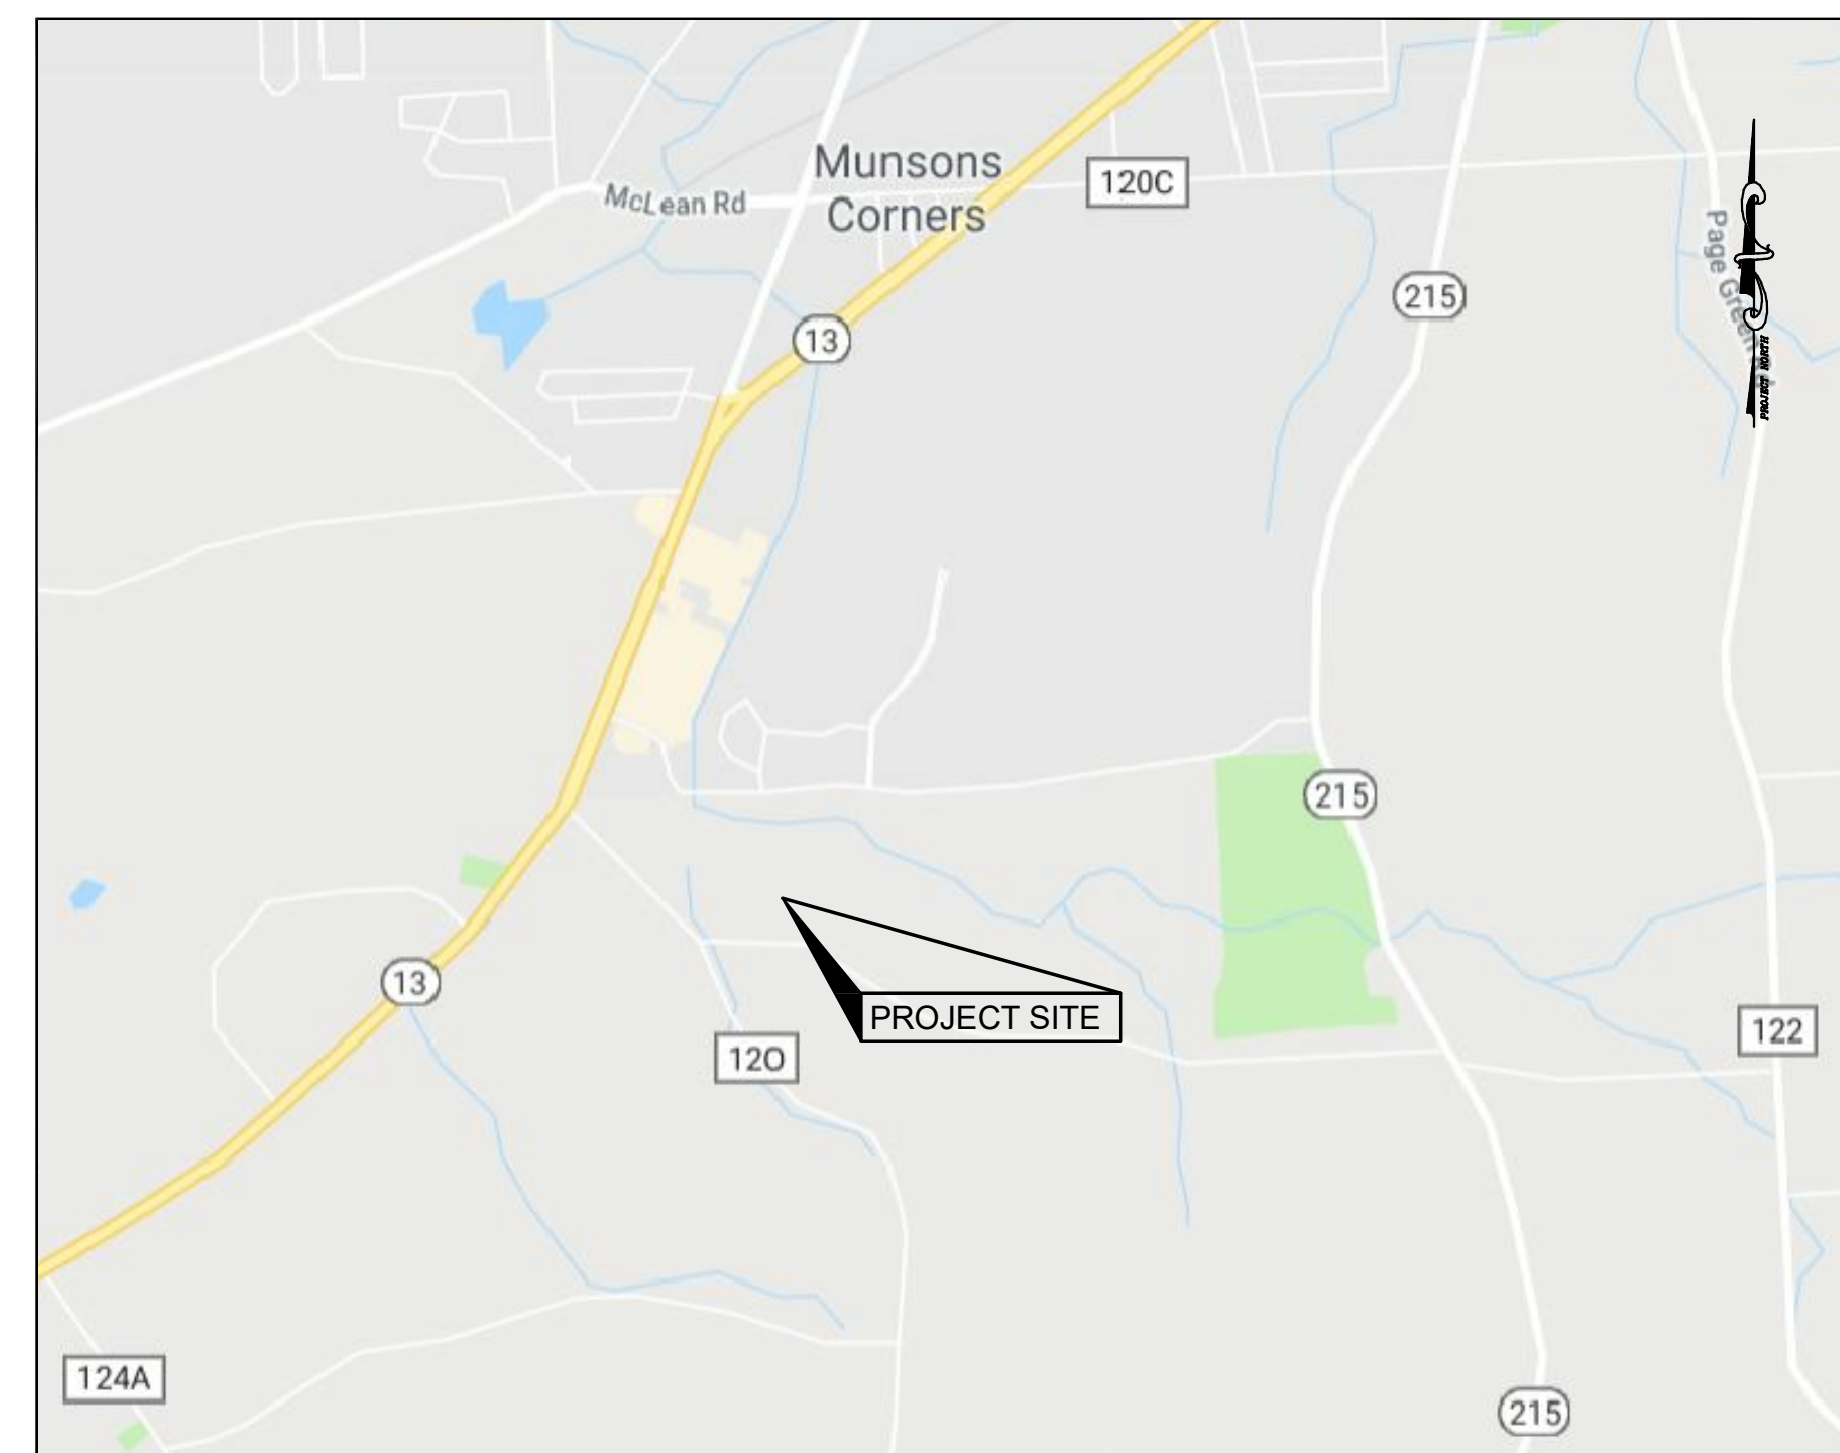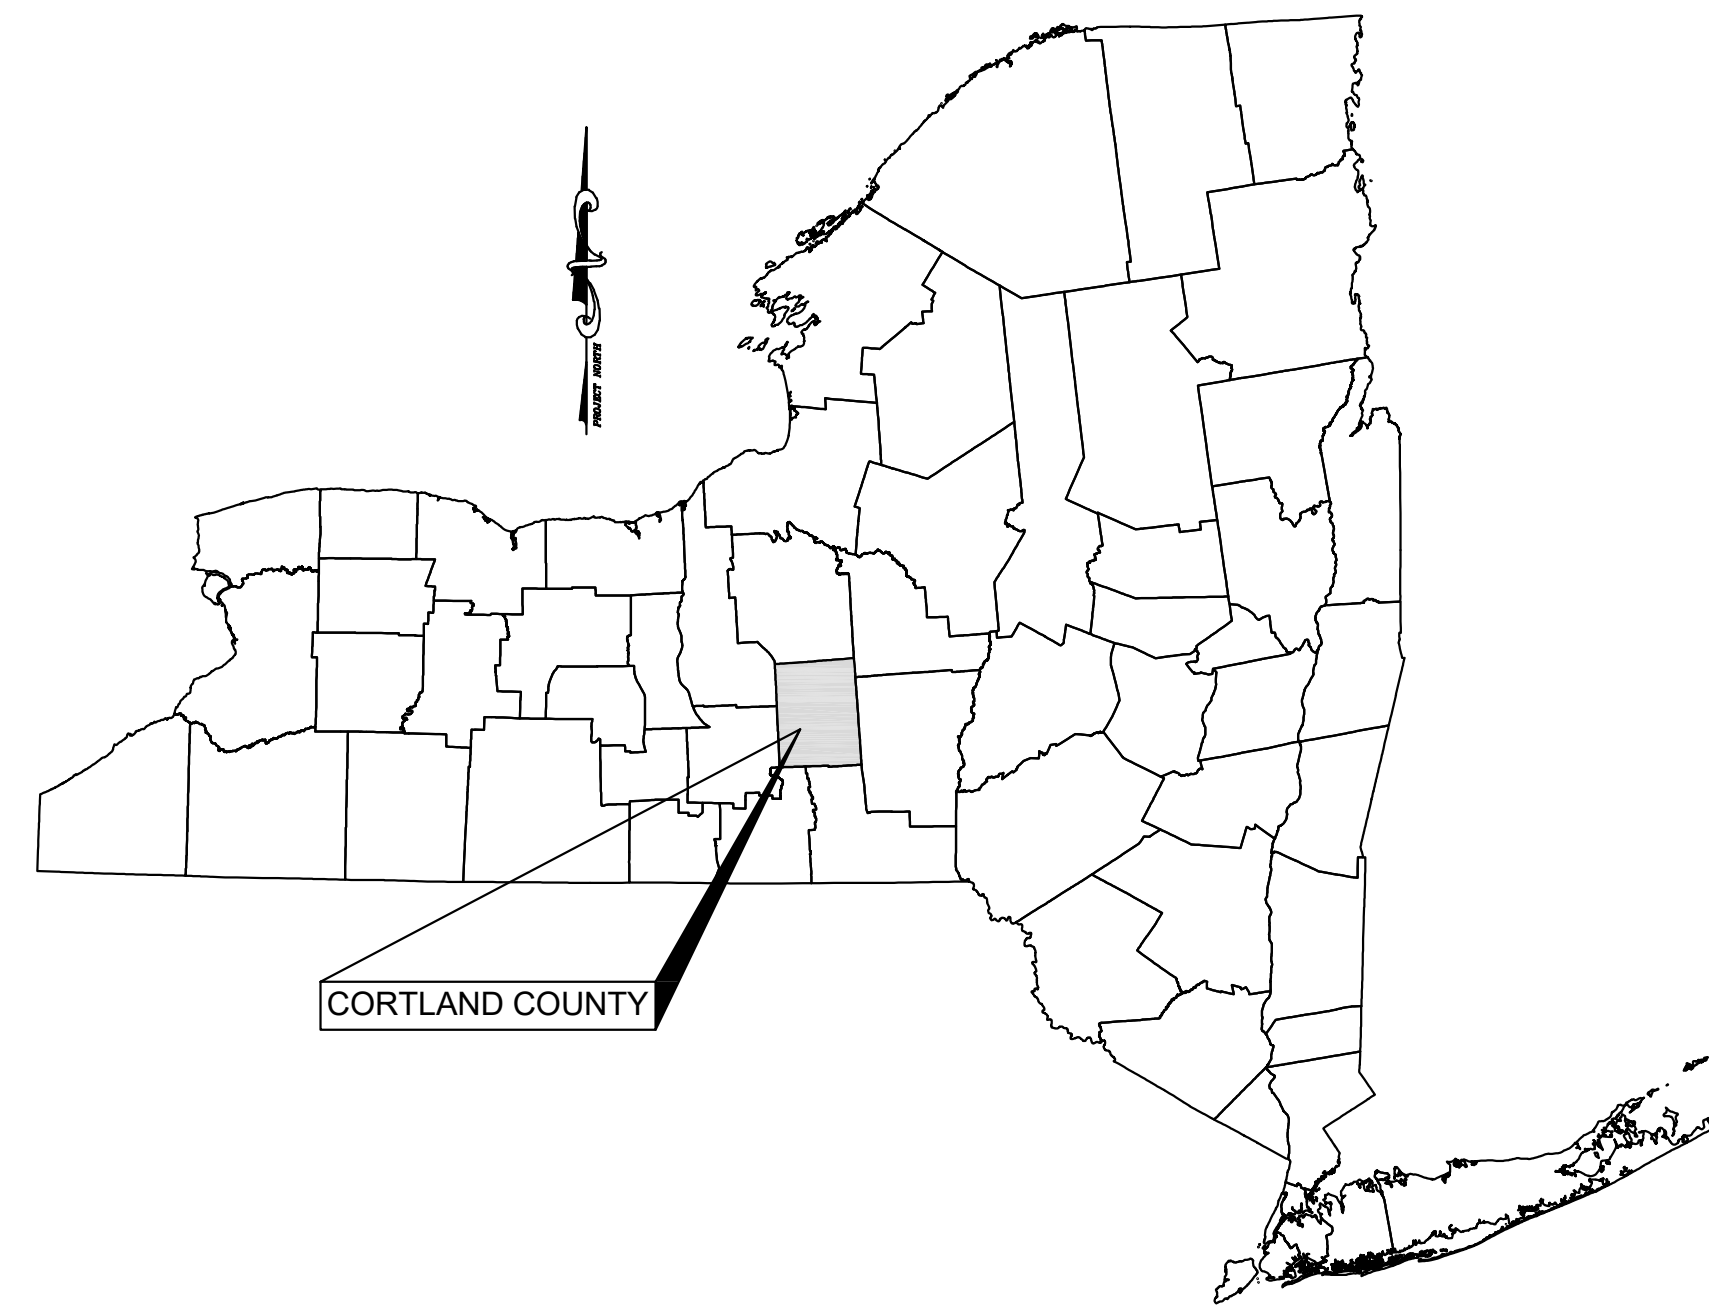

LOCATION MAP
 SCALE 1" = 2000'


DRAWINGS PREPARED BY

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PROJECT NO. 2850.24418.6


DECEMBER 18, 2018
 REVISED: FEBRUARY 12, 2019

MARK W. PARKER, P.E. LIC. No. 093972
 ALTERATIONS NOT CONFORMING TO SECTION 7209, SUBDIVISION 2,
 NEW YORK STATE EDUCATION LAW ARE PROHIBITED BY LAW.

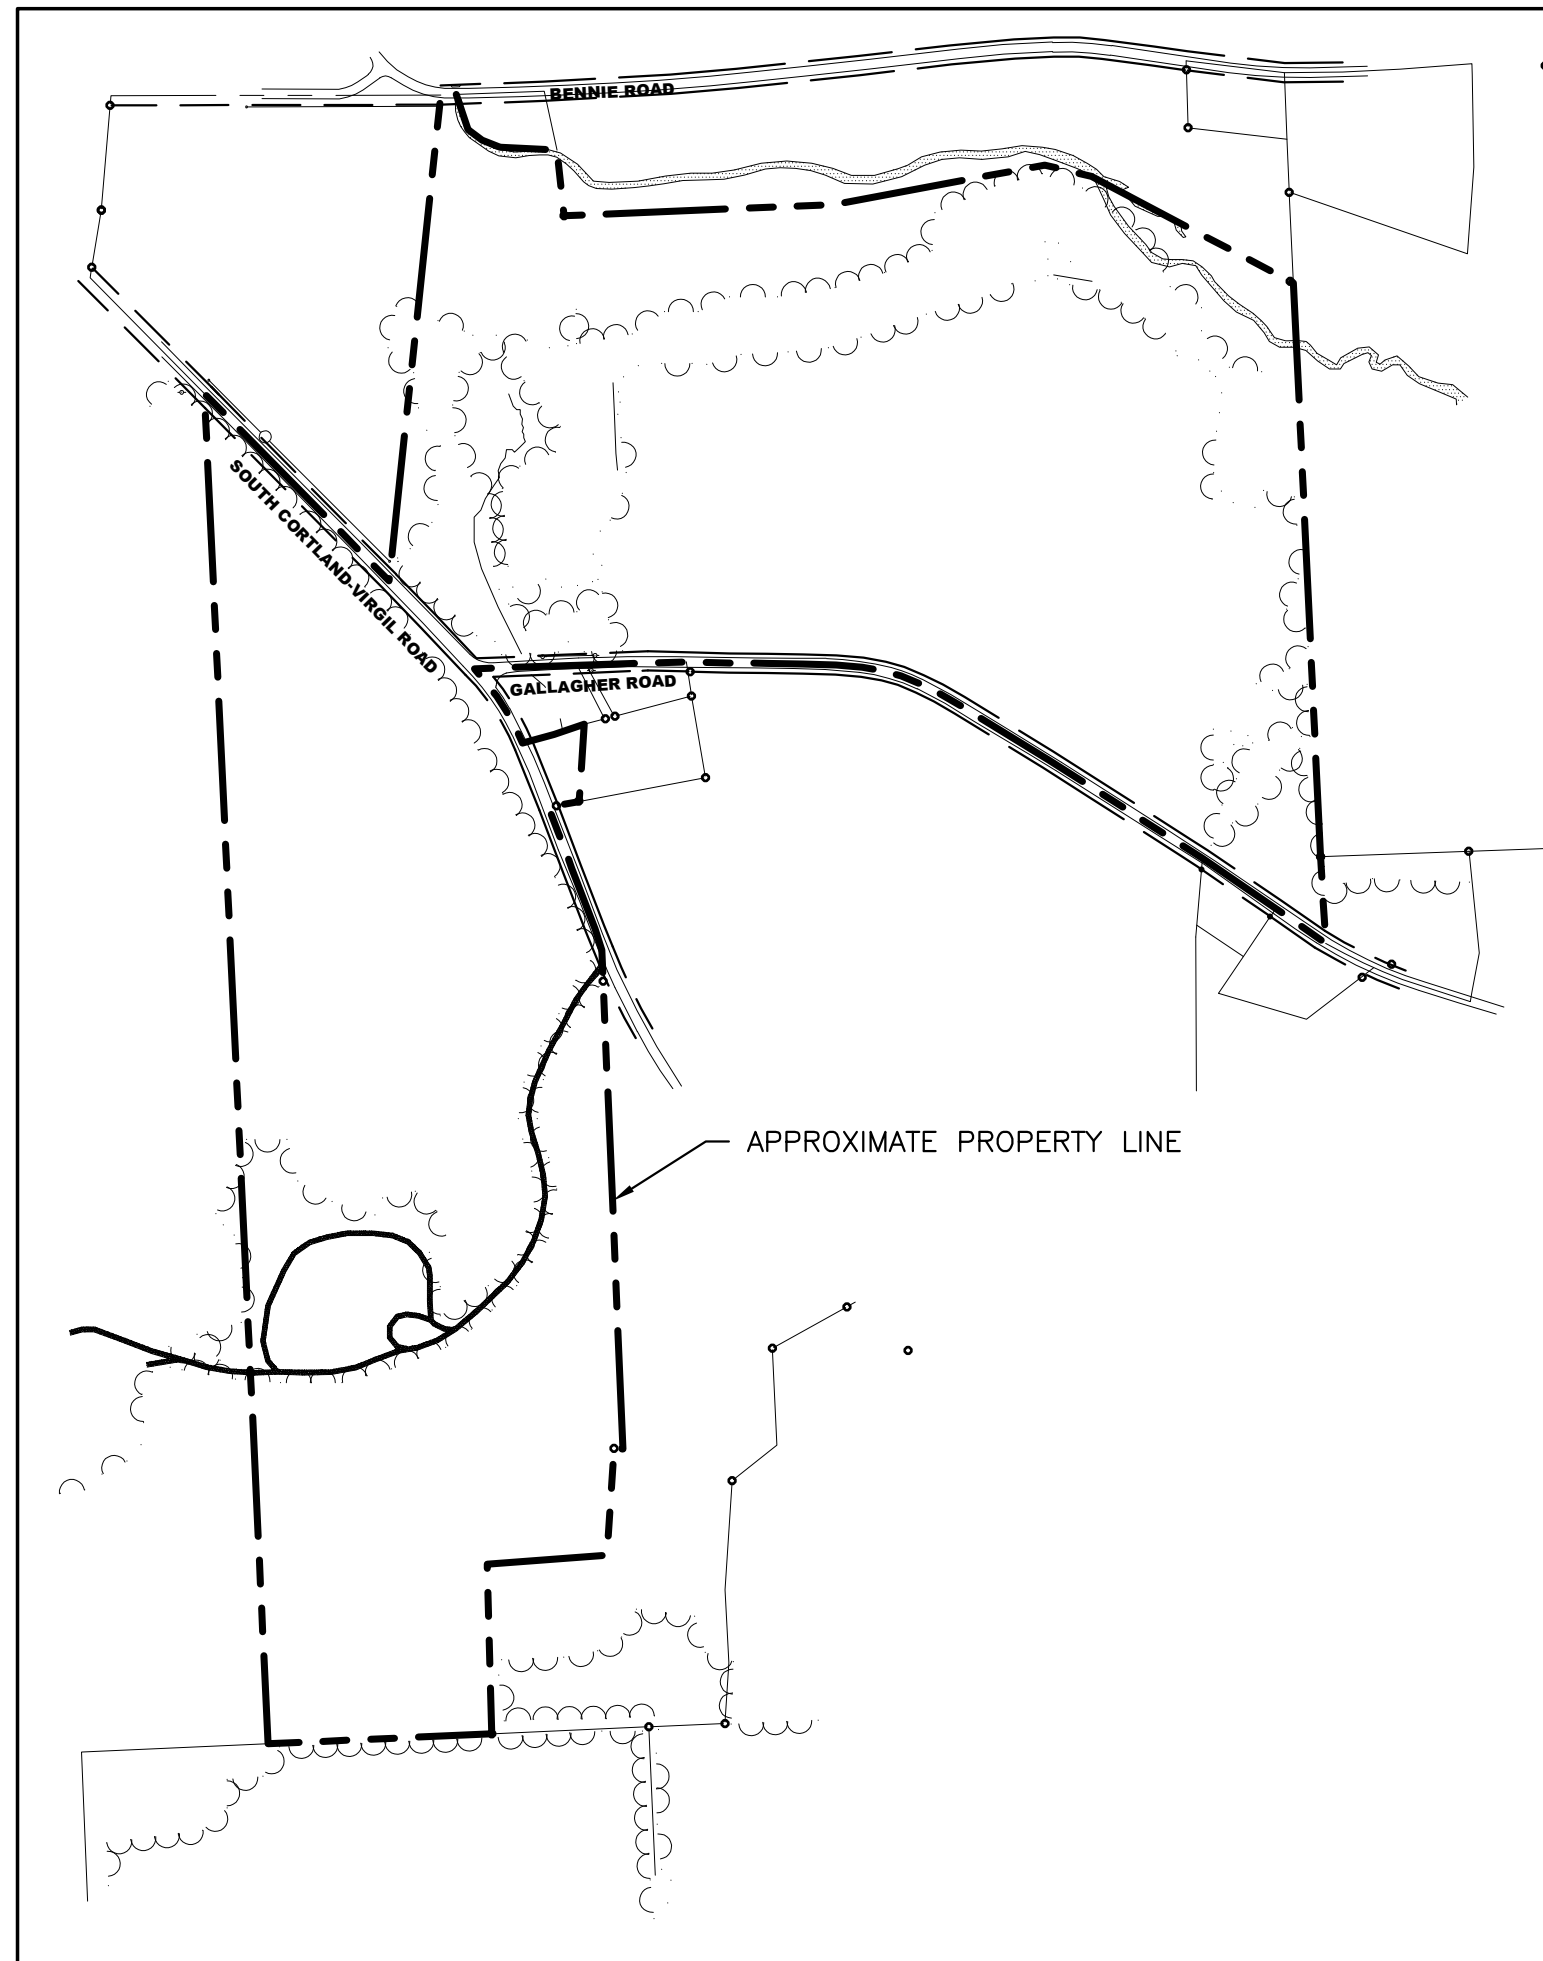

OVERALL PROPERTY MAP

1" = 500'

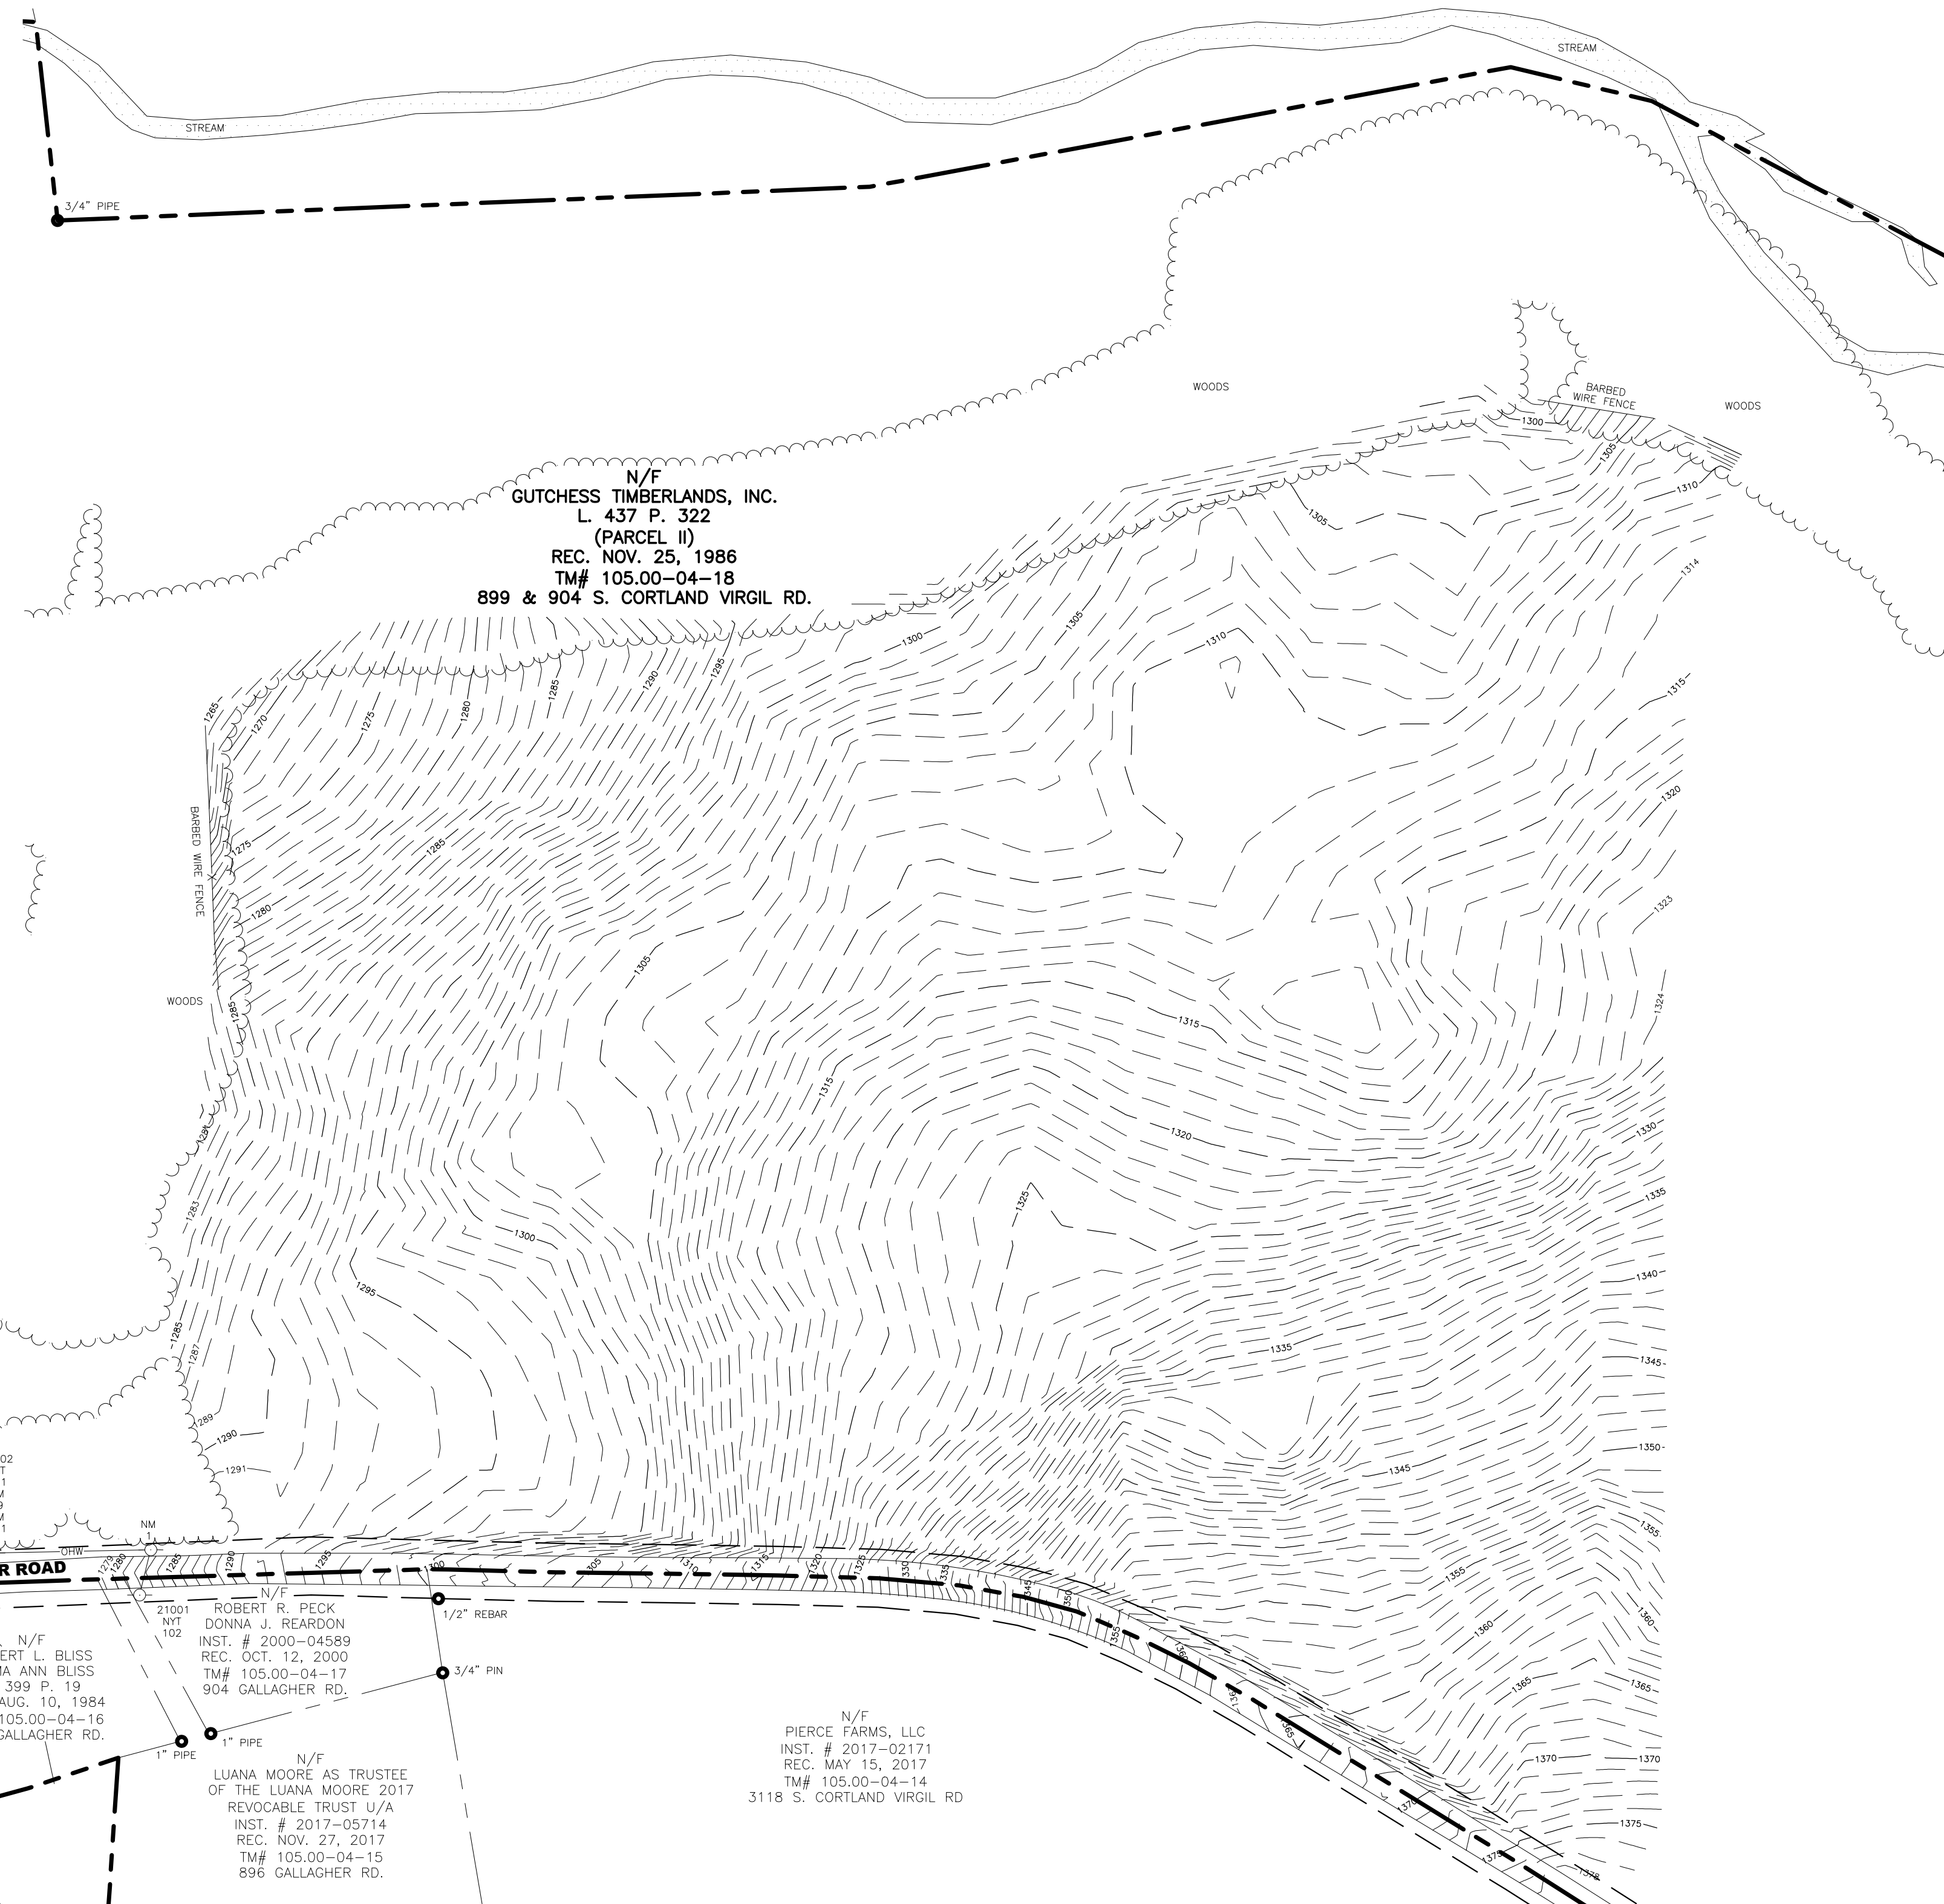

GRAPHIC SCALE



(IN FEET)
1 inch = 100 ft.

LEGEND

- MONUMENT FOUND AND NOTED
- N/F NOW OR FORMERLY
- TM# TAX MAP NUMBER
- PROPERTY LINE
- UTILITY POLE
- OHW OVERHEAD UTILITIES
- SPOT ELEVATION

NOTES


1. FIELD SURVEY WAS COMPLETED ON NOVEMBER 21, 2018.
2. HORIZONTAL DATUM IS REFERENCED TO NEW YORK STATE PLANE COORDINATE SYSTEM, CENTRAL ZONE, NAD 83.
3. VERTICAL DATUM IS REFERENCED TO NORTH AMERICAN VERTICAL DATUM 1988.
4. AT THE TIME OF THE SURVEY THERE WAS APPROXIMATELY 4 INCHES OF SNOW ON THE GROUND.

ALL UNDERGROUND UTILITIES ARE APPROXIMATE.

UNDERGROUND UTILITY LOCATIONS MARKED BY UTILITY OWNERS PER A "DESIGN TICKET" CALLED IN TO "DIG SAFELY NEW YORK" PRIOR TO FIELD SURVEY HAVE BEEN SHOWN.

THE USER OF THIS MAP IS CAUTIONED THAT THE UNDERGROUND UTILITY LOCATIONS ARE NOT GUARANTEED, NOR IS THERE ANY GUARANTEE THAT ALL EXISTING UTILITIES WHETHER FUNCTIONAL OR ABANDONED WITHIN THE PROJECT AREA ARE SHOWN ON THIS DRAWING.

THE CONTRACTOR SHALL DETERMINE THE EXACT LOCATION OF ALL UNDERGROUND UTILITIES BEFORE STARTING WORK & SHALL BE RESPONSIBLE FOR ALL DAMAGE RESULTING FROM HIS WORK. CONTRACTOR SHALL NOTIFY DIG SAFELY NY (FORMERLY UFPO) 1-800-962-7962 IN ACCORDANCE WITH 16 NYCRR PART 753.

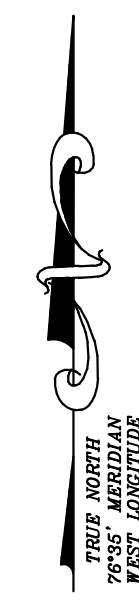

NOT FOR CONSTRUCTION

SOLAR ARRAY PLAN
CORTLAND-VIRGIL ROAD SOLAR
301 SOUTH CORTLAND VIRGIL ROAD
TOWN OF CORTLANDVILLE
CORTLAND COUNTY, NY

EXISTING SITE CONDITIONS

SHEET NO.
C010

PROJECT NO.
2850.24418.6

DATE: 12/18/18

CAD FILE NO: 285024418_6_Site.dwg

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Professional Land Surveyor Law to
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NO.	REVISIONS AND DESCRIPTIONS	DATE
1	SOLAR PANEL ARRAY PLAN	2/12/18

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GENERAL NOTES


- 1) CONTRACTOR SHALL NOT PROCEED WITH ANY CONSTRUCTION WORK PRIOR TO FINAL APPROVAL OF ALL PLANS AND SECURING OF ALL PERMITS.
- 2) CONTRACTOR SHALL PROVIDE CONSTRUCTION/PROTECTIVE FENCING OR OTHER MEANS NECESSARY TO PROTECT WORK AND TO ENSURE THE SAFETY OF PEDESTRIAN AND VEHICULAR TRAFFIC DURING CONSTRUCTION.
- 3) CONTRACTOR TO COMPLY WITH ALL O.S.H.A. AND OTHER STATE AND LOCAL SAFETY REQUIREMENTS DURING CONSTRUCTION. (PROPER SHORING, ETC.)
- 4) THE CONTRACTOR SHALL PROTECT AND SUSTAIN IN NORMAL SERVICE ALL EXISTING UTILITIES, STRUCTURES, EQUIPMENT, ROADWAYS AND DRIVEWAYS.
- 5) ELECTRIC AND GAS INSTALLATION AND CONNECTIONS TO BE IN ACCORDANCE WITH UTILITY COMPANY REGULATIONS AND REQUIREMENTS.
- 6) THE CONTRACTOR SHALL FILL IN, AND THEN RE-EXCAVATE AS NECESSARY TO RESUME WORK, ANY EXCAVATIONS OR TRENCHES AT LOCATIONS AND AS OFTEN AS MAY BE REQUIRED TO ENSURE PROTECTION OF THE WORK, ANY ADJACENT EXISTING FACILITIES, OR THE PUBLIC.
- 7) THE CONTRACTOR SHALL CLEAN UP THE JOB SITE ON A DAILY BASIS BEFORE LEAVING THE JOB. ALL RUBBISH MUST BE CLEANED UP AND CONSTRUCTION EQUIPMENT MUST BE PROPERLY TAKEN CARE OF AND STORED AT THE END OF THE DAY.
- 8) CONTRACTOR SHALL RESTORE ALL LAWNS, DRIVEWAYS, WALKS, WALL, CURBS, FENCES, ETC. DISTURBED BY CONSTRUCTION. LAWN SHALL BE FINE GRADED, SEEDED, FERTILIZED AND MULCHED PER ACCEPTABLE LANDSCAPE PRACTICES.
- 9) CONTRACTOR IS RESPONSIBLE FOR CONSTRUCTION STAKEOUT. WHERE APPLICABLE STAKEOUT SHALL BE COMPLETED BY A LICENSED LAND SURVEYOR.
- 10) UNDERGROUND UTILITY LOCATIONS ARE NOT GUARANTEED, NOR IS THERE ANY GUARANTEE THAT ALL EXISTING UTILITIES WHETHER FUNCTIONAL OR ABANDONED WITHIN THE PROJECT AREA ARE SHOWN ON THIS DRAWING. THE CONTRACTOR SHALL DETERMINE THE EXACT LOCATION OF ALL UNDERGROUND UTILITIES BEFORE STARTING WORK & SHALL BE RESPONSIBLE FOR ALL DAMAGE RESULTING FROM HIS WORK. CONTRACTORS SHALL NOTIFY DIG SAFELY NY (FORMERLY UFPO) 1-800-962-7962 IN ACCORDANCE WITH 16 NYCRR PART 753.
- 11) ALL SITE WORK SHALL BE SMOOTHLY AND EVENLY BLENDED INTO EXISTING CONDITIONS.
- 12) ALL BOUNDARY AND/OR TOPOGRAPHIC INFORMATION OBTAINED FROM SURVEY PREPARED BY KEYSTONE ASSOCIATES ARCHITECTS, ENGINEERS AND SURVEYORS, LLC. IT IS THE BASE INFORMATION USED TO PREPARE THE WORK INDICATED ON THE DRAWINGS. BY INCLUSION OF THIS SURVEY INFORMATION IN THIS SET OF DOCUMENTS, KEYSTONE ASSOCIATES ARCHITECTS, ENGINEERS AND SURVEYORS, LLC DOES NOT ASSUME RESPONSIBILITY FOR INTERPRETATIONS OR CONCLUSIONS DRAWN THEREFROM BY THE CONTRACTOR.

ZONING NOTES



ZONING DISTRICT: AGRICULTURAL
 USE: GROUND-MOUNTED LARGE-SCALE SOLAR ENERGY SYSTEM

	ZONING REQUIRED	SOLAR REQUIRED	ACTUAL
MINIMUM LOT SIZE:	5 AC	N/A	136.1 AC
MINIMUM LOT FRONTAGE:	300 LF	N/A	1,812.4 LF
MAXIMUM LOT COVERAGE:	20%	40%	8.33%
MINIMUM YARD DIMENSIONS:			
PRINCIPAL:			
FRONT	75 LF	N/A	N/A
REAR	100 LF	N/A	N/A
SIDE	100 LF	N/A	N/A
ACCESSORY:			
FRONT	N/A	50 LF	105.0 LF
REAR	N/A	50 LF	369.4 LF
TO PRINCIPAL	N/A	N/A	N/A
SIDE	N/A	50 LF	628.4 LF
MAXIMUM STRUCTURE HEIGHT:	NONE	20 FT	12 FT

TOTAL ACREAGE OF PROJECT: ± 12.25 ACRES
 TOTAL ACREAGE TO BE DISTURBED: ± 0.73 ACRES

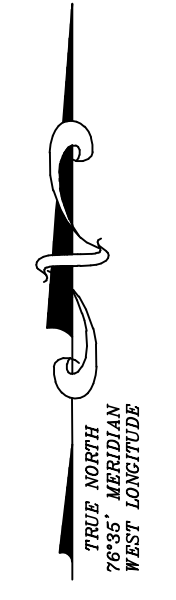

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 It is a violation of Section 7705 of the Education Law to use any person unless that person is duly licensed as a Professional Architect, Engineer, or Surveyor. Any person who violates this section shall be deemed to be practicing as such without being duly licensed and shall be liable for the same as if he or she were so licensed. No person shall be deemed to be practicing as such unless he or she is duly licensed and his or her name has been entered on the State Register of Professional Engineers and Surveyors.
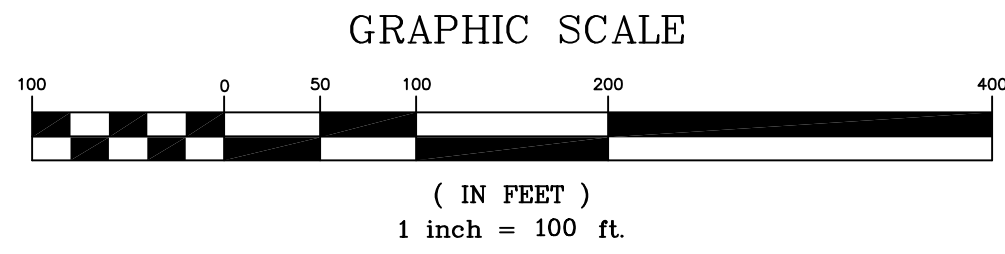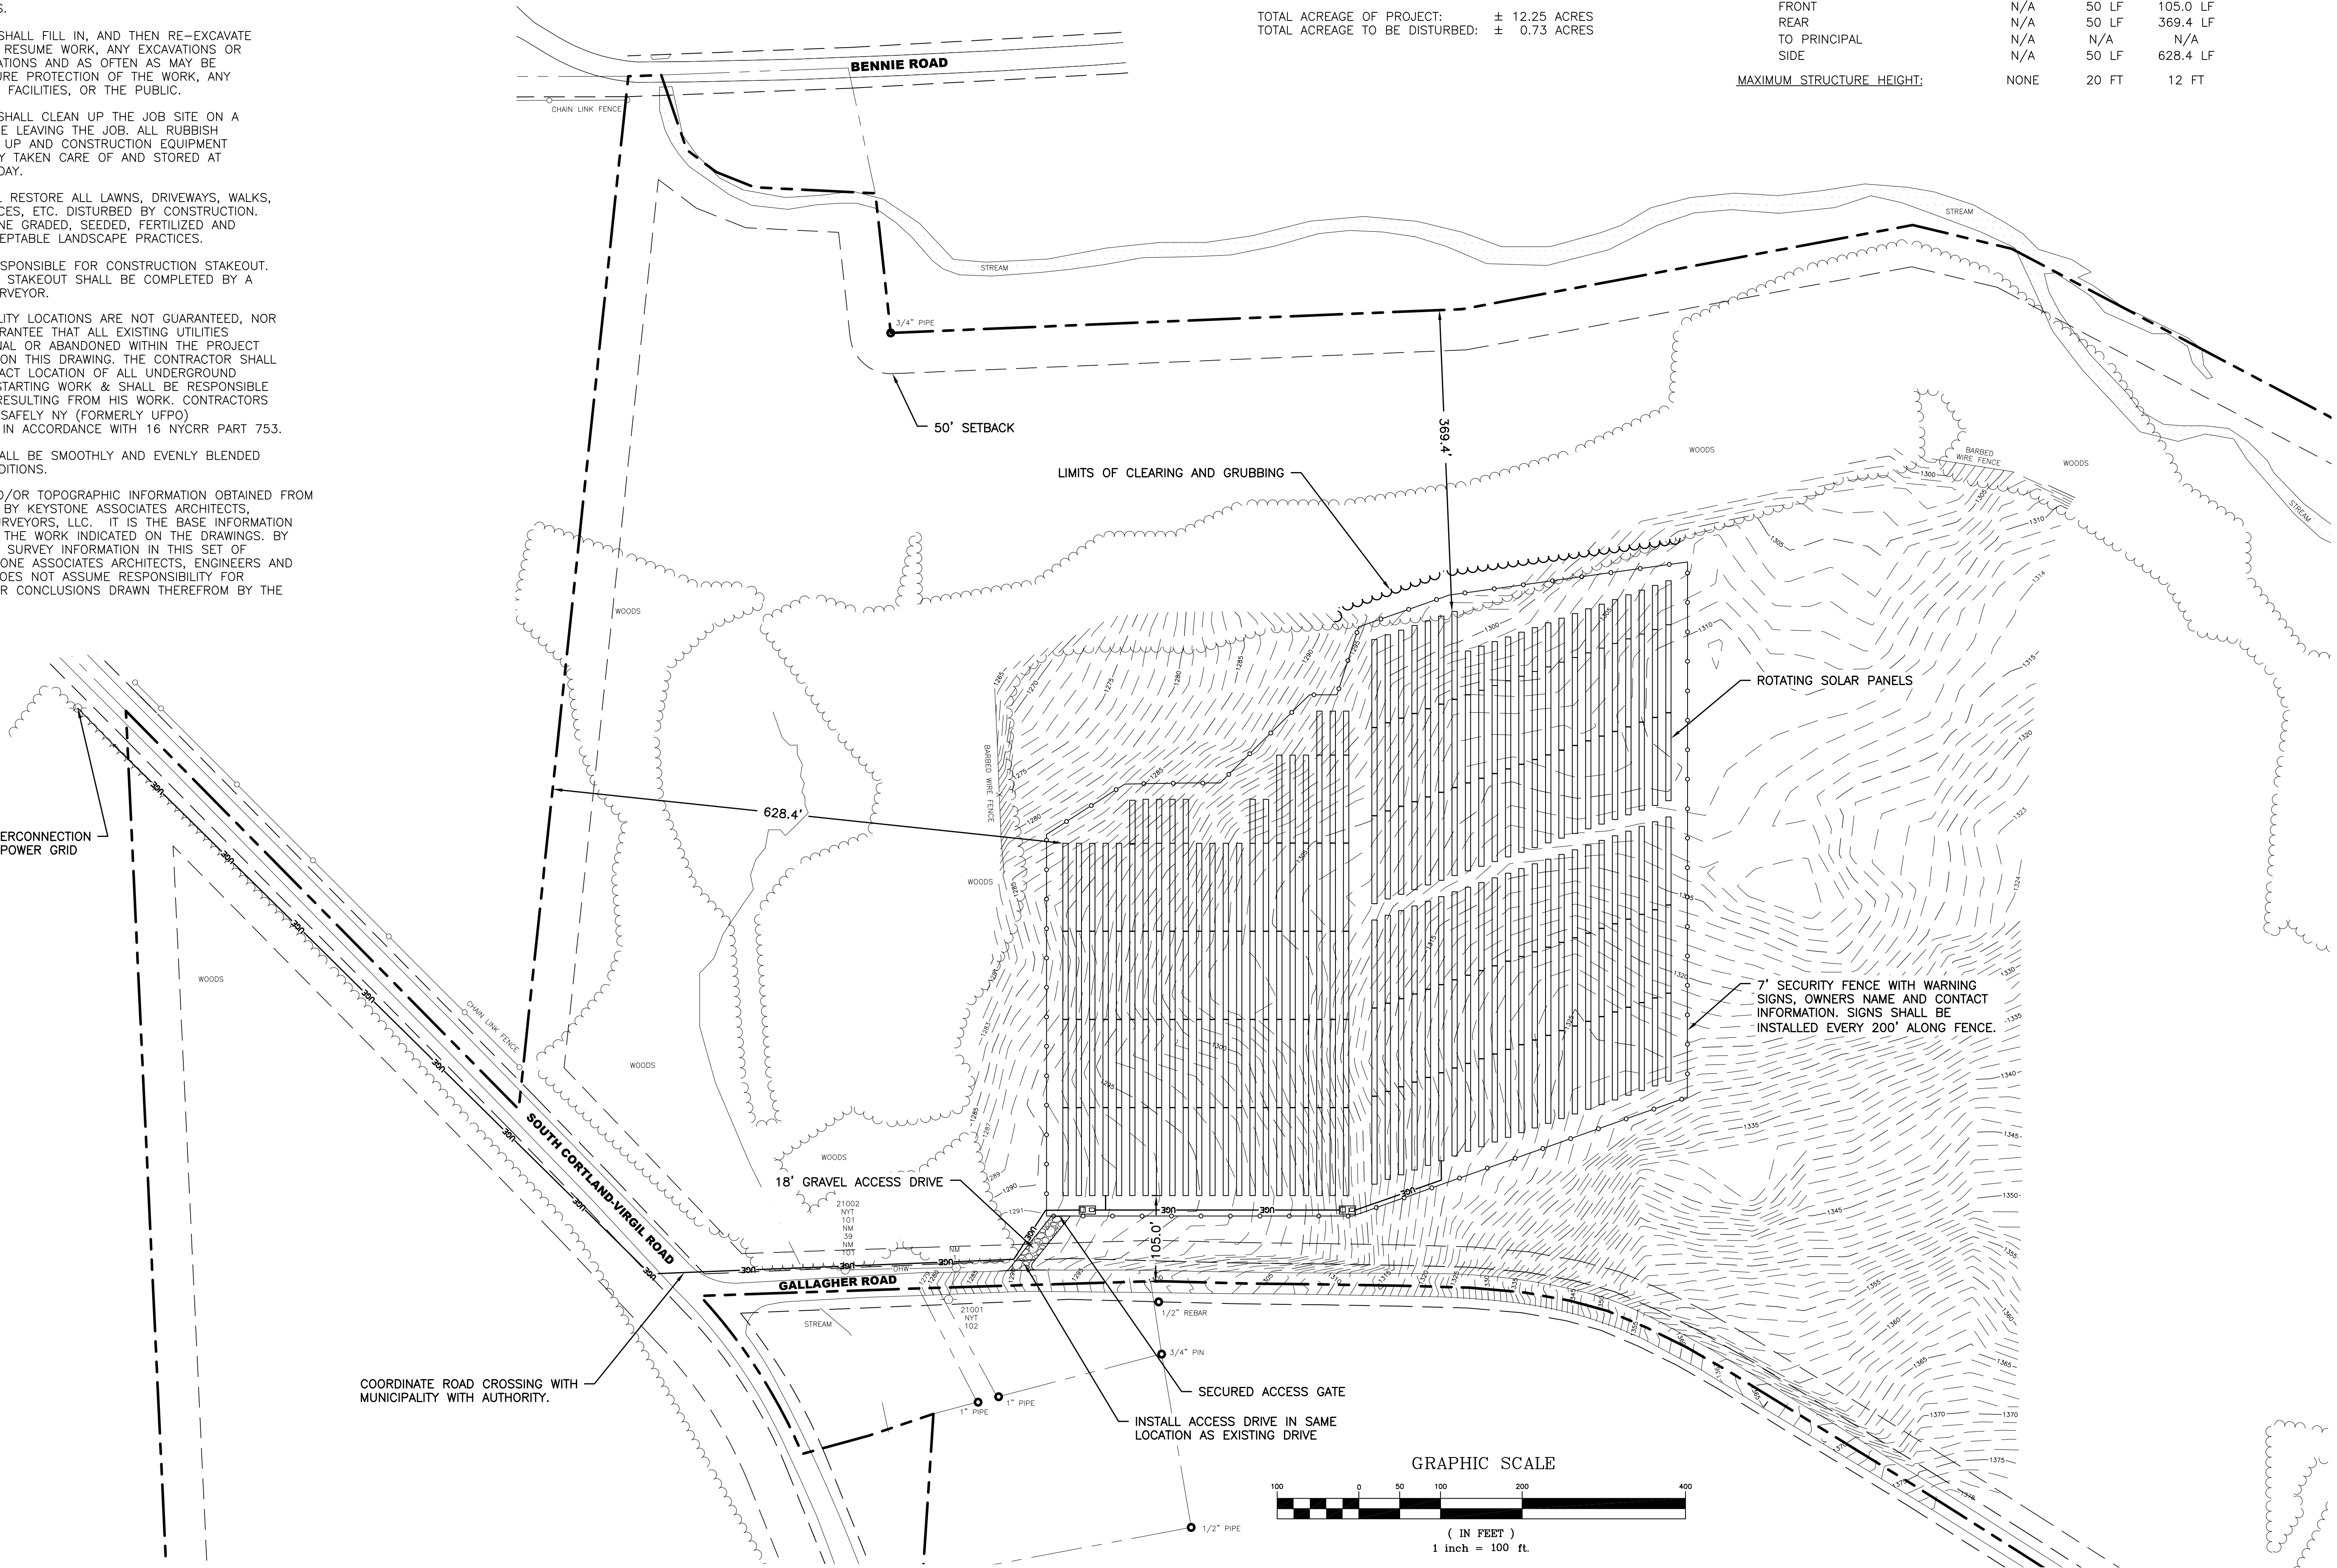
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SOLAR ARRAY PLAN
CORTLAND-VIRGIL ROAD SOLAR
 301 SOUTH CORTLAND VIRGIL ROAD
 TOWN OF CORTLANDVILLE
 CORTLAND COUNTY, NY

SITE PLAN

SHEET NO.
C100

PROJECT NO.
 2850.24418.6

DATE: 12/18/18

CAD FILE NO.: 285024418_6_Site.dwg

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NOTES:

1. SOLAR ARRAY SUPPORTS AND CHAIN LINK FENCE POST SHALL BE DRIVEN OR DIRECT AUGERED, THEREFORE THEY DO NOT MEET THE NYSDEC DEFINITION FOR LAND DISTURBANCE.
2. CONTRACTOR SHALL BACKFILL ALL TRENCHES ON THE SAME DAY AS THEY ARE EXCAVATED. SEEDING AND MULCHING SHALL OCCUR IMMEDIATELY AFTER TRENCHING HAS BEEN COMPLETED.
3. IF THE E&SC MEASURES THAT ARE SHOWN DO NOT PROVE TO BE EFFECTIVE, THE CONTRACTOR SHALL IMMEDIATELY CONTACT THE ENGINEER OF RECORD FOR RECOMMENDATIONS OF ADDITIONAL MEASURES TO INSTALL.
4. CONTRACTOR SHALL NOT EXCAVATE FOR ROAD OR UNDERGROUND UTILITIES MORE THAN THEY CAN BACKFILL IN THE SAME DAY.

CONCRETE WASHOUT	CW
DUST CONTROL	DC
TOPSOILING	TS
PERMANENT SEEDING	PS
MULCHING	M
STABILIZED CONSTRUCTION ENTRANCE	
SILT FENCE	

U.S. DEPARTMENT OF AGRICULTURE
NATURAL RESOURCES CONSERVATION SERVICE
NEW YORK STATE DEPARTMENT OF ENVIRONMENTAL CONSERVATION
NEW YORK STATE SOIL & WATER CONSERVATION COMMITTEE

STANDARD SYMBOLS

CONSTRUCTION SEQUENCE

1. INSTALL STABILIZED CONSTRUCTION ENTRANCE.
2. INSTALL SILT FENCE.
3. INSTALL GRAVEL ACCESS DRIVE.
4. INSTALL SOLAR BASE SUPPORTS AND SOLAR ARRAYS.
5. INSTALL UNDERGROUND UTILITIES AND UTILITY POLES.
6. INSTALL CHAIN LINK FENCE AND OTHER AMENITIES.
7. INSTALL SEED AND MULCH TO ALL DISTURBED AREAS.
8. AFTER ALL AREAS HAVE MET THE REQUIREMENTS OF FINAL STABILIZATION, REMOVE ALL TEMPORARY EROSION AND SEDIMENT CONTROL MEASURES.



OVERSEE ALL AREAS WITHIN FENCE TO ENSURE FULL UNIFORM HEALTHY GROWTH OF GRASS IS ESTABLISHED.

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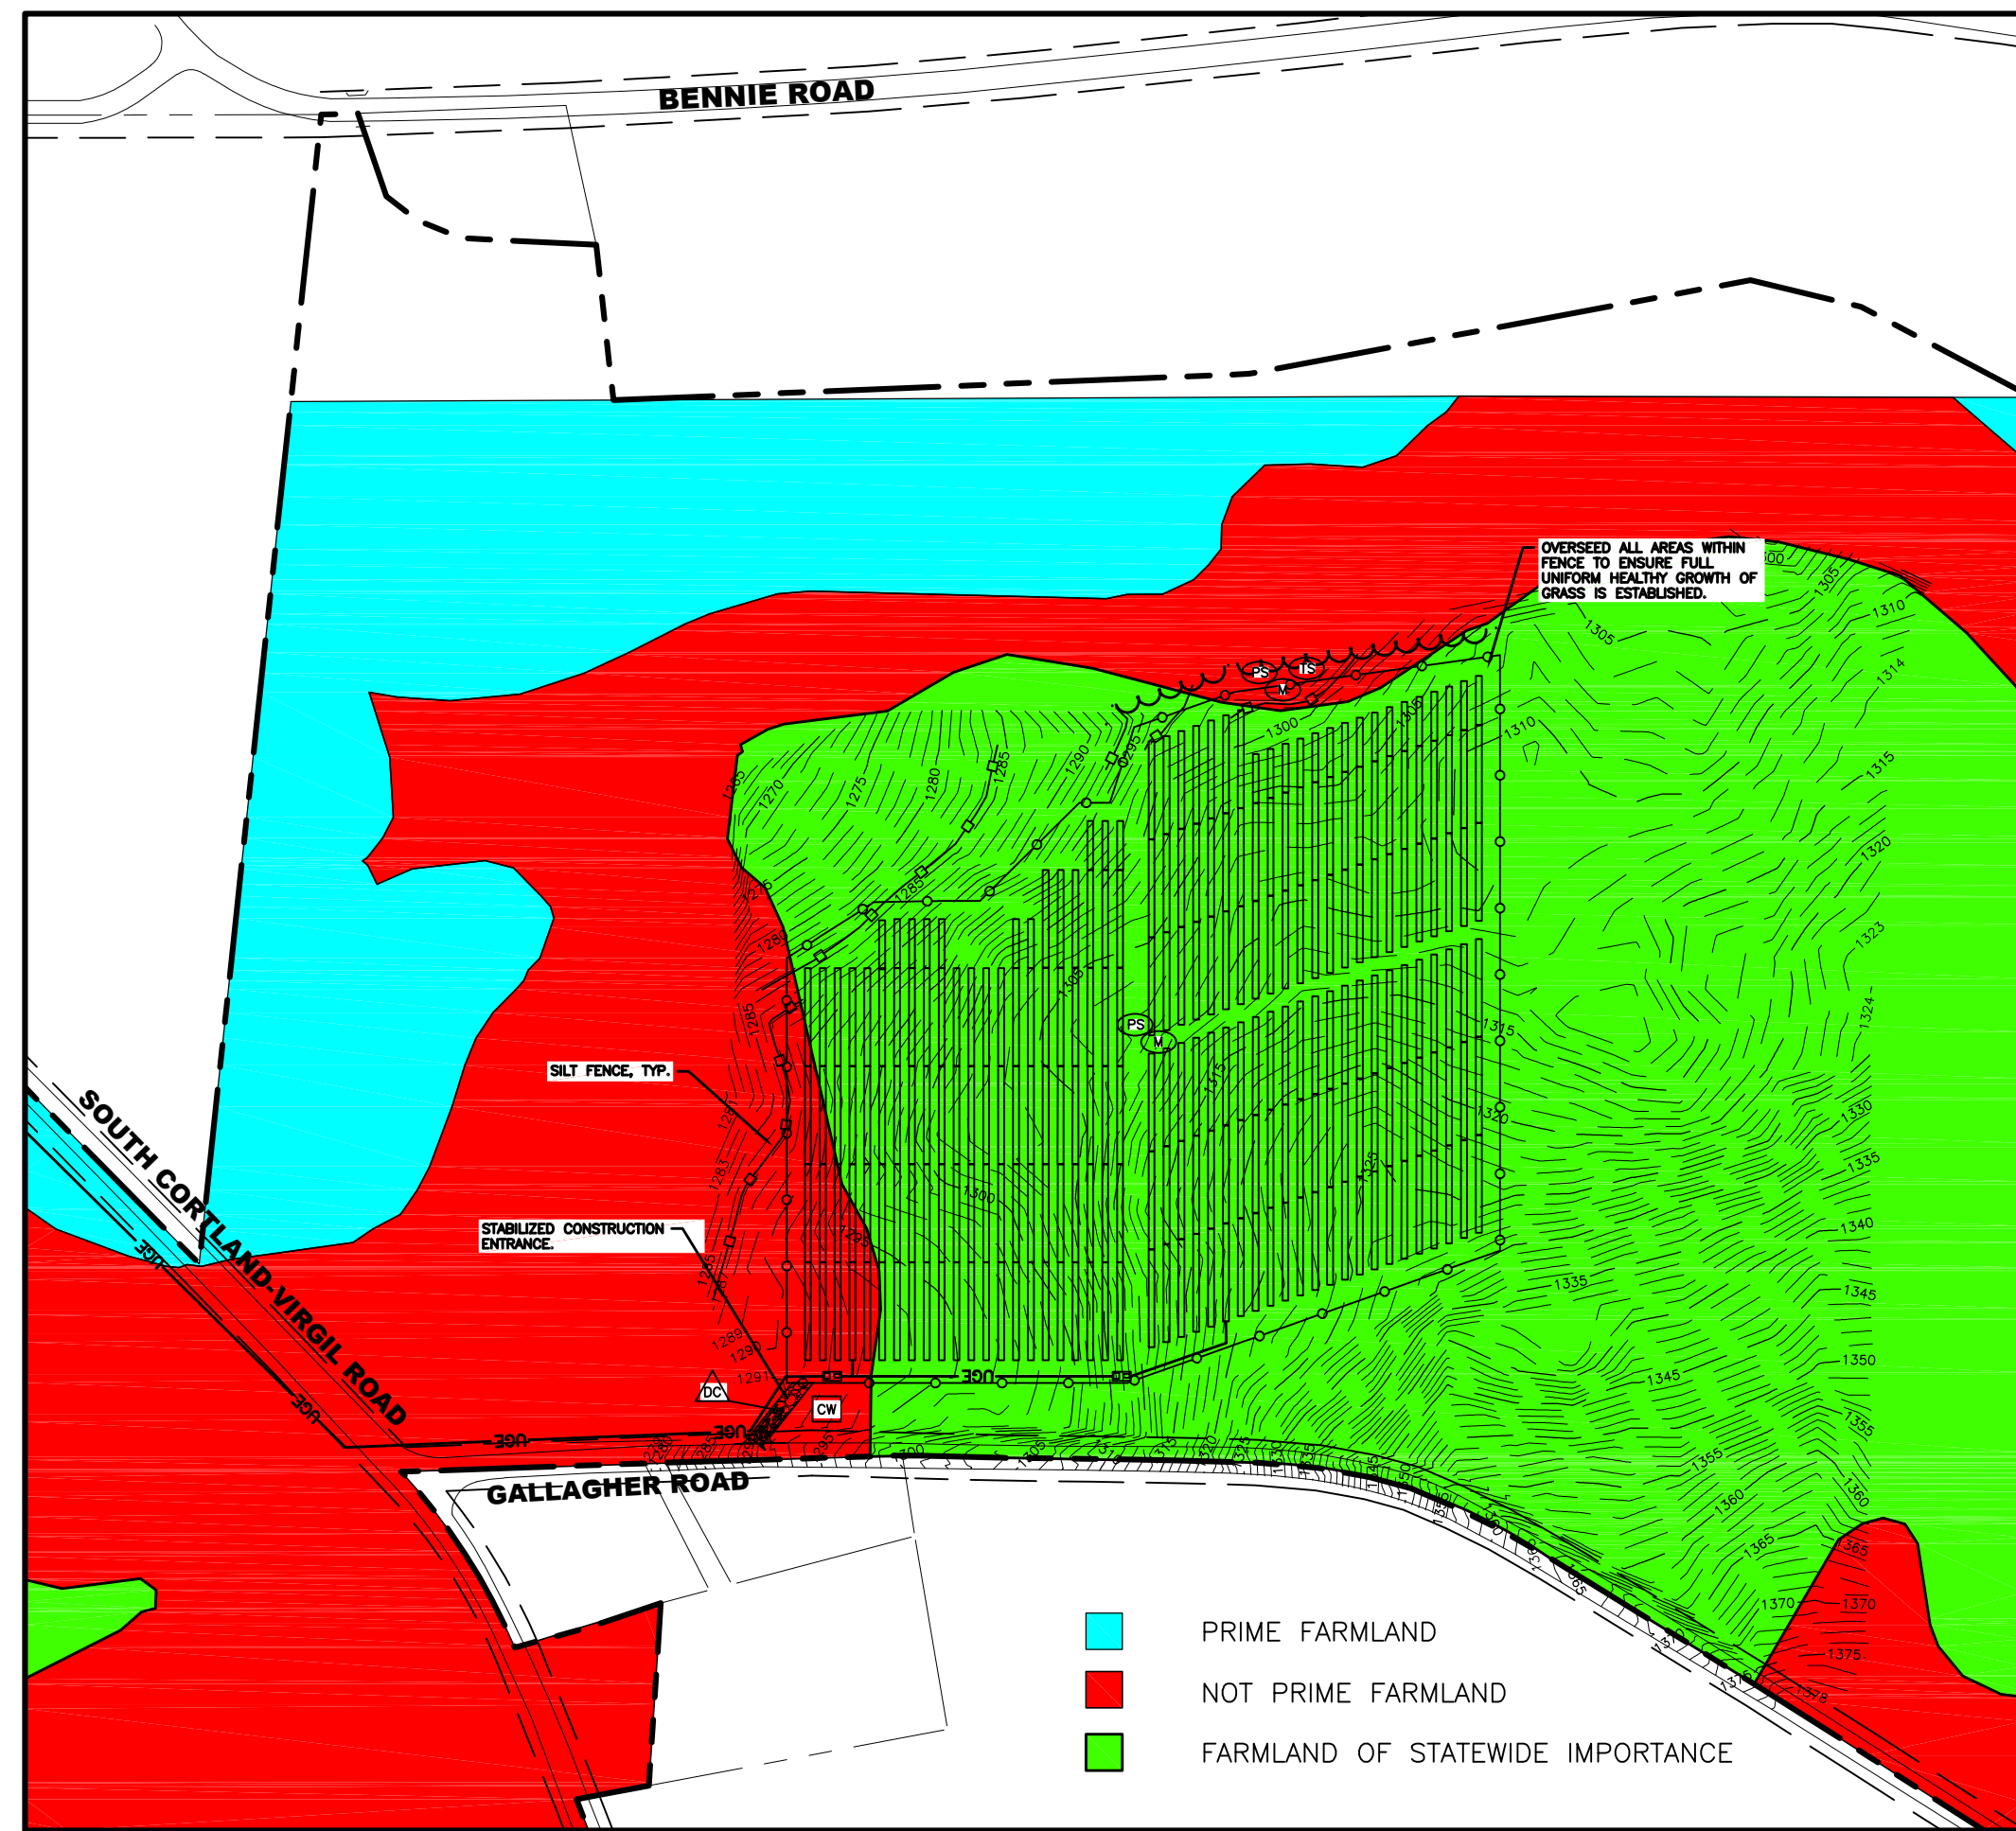
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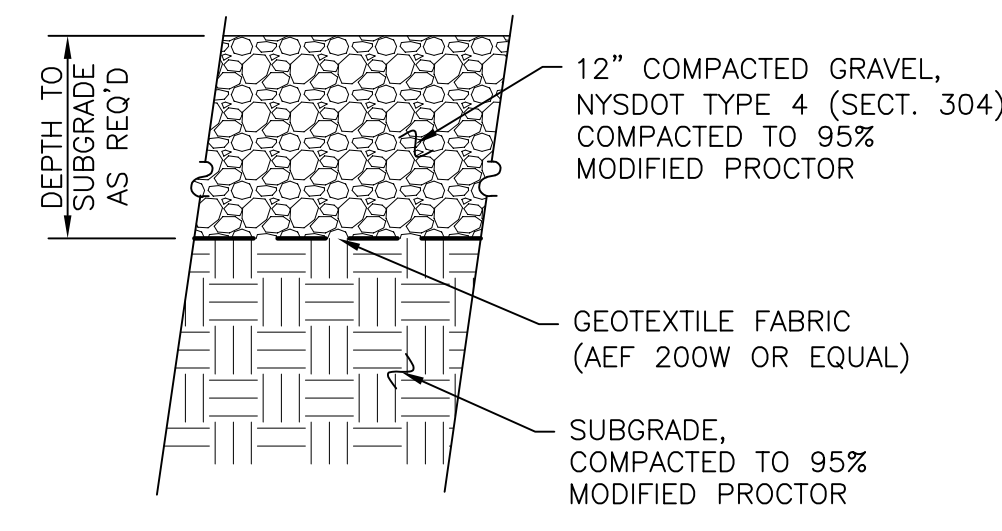
<p>SOLAR ARRAY PLAN CORTLAND-VIRGIL ROAD SOLAR 301 SOUTH CORTLAND VIRGIL ROAD TOWN OF CORTLANDVILLE CORTLAND COUNTY, NY</p>	<p>EROSION AND SEDIMENT CONTROL PLAN</p>
<p>SHEET NO. C110</p>	
<p>PROJECT NO. 2850.24418.6</p>	
<p>DATE: 12/18/18</p>	
<p>CAD FILE NO.: 285024418_6_Site.dwg</p>	

WARNING: This is a portion of a larger drawing. The entire drawing is required for proper interpretation. The user is advised to consult the project files for the complete drawing. No responsibility is assumed for any errors or omissions. The user is advised to consult the project files for the complete drawing. No responsibility is assumed for any errors or omissions.


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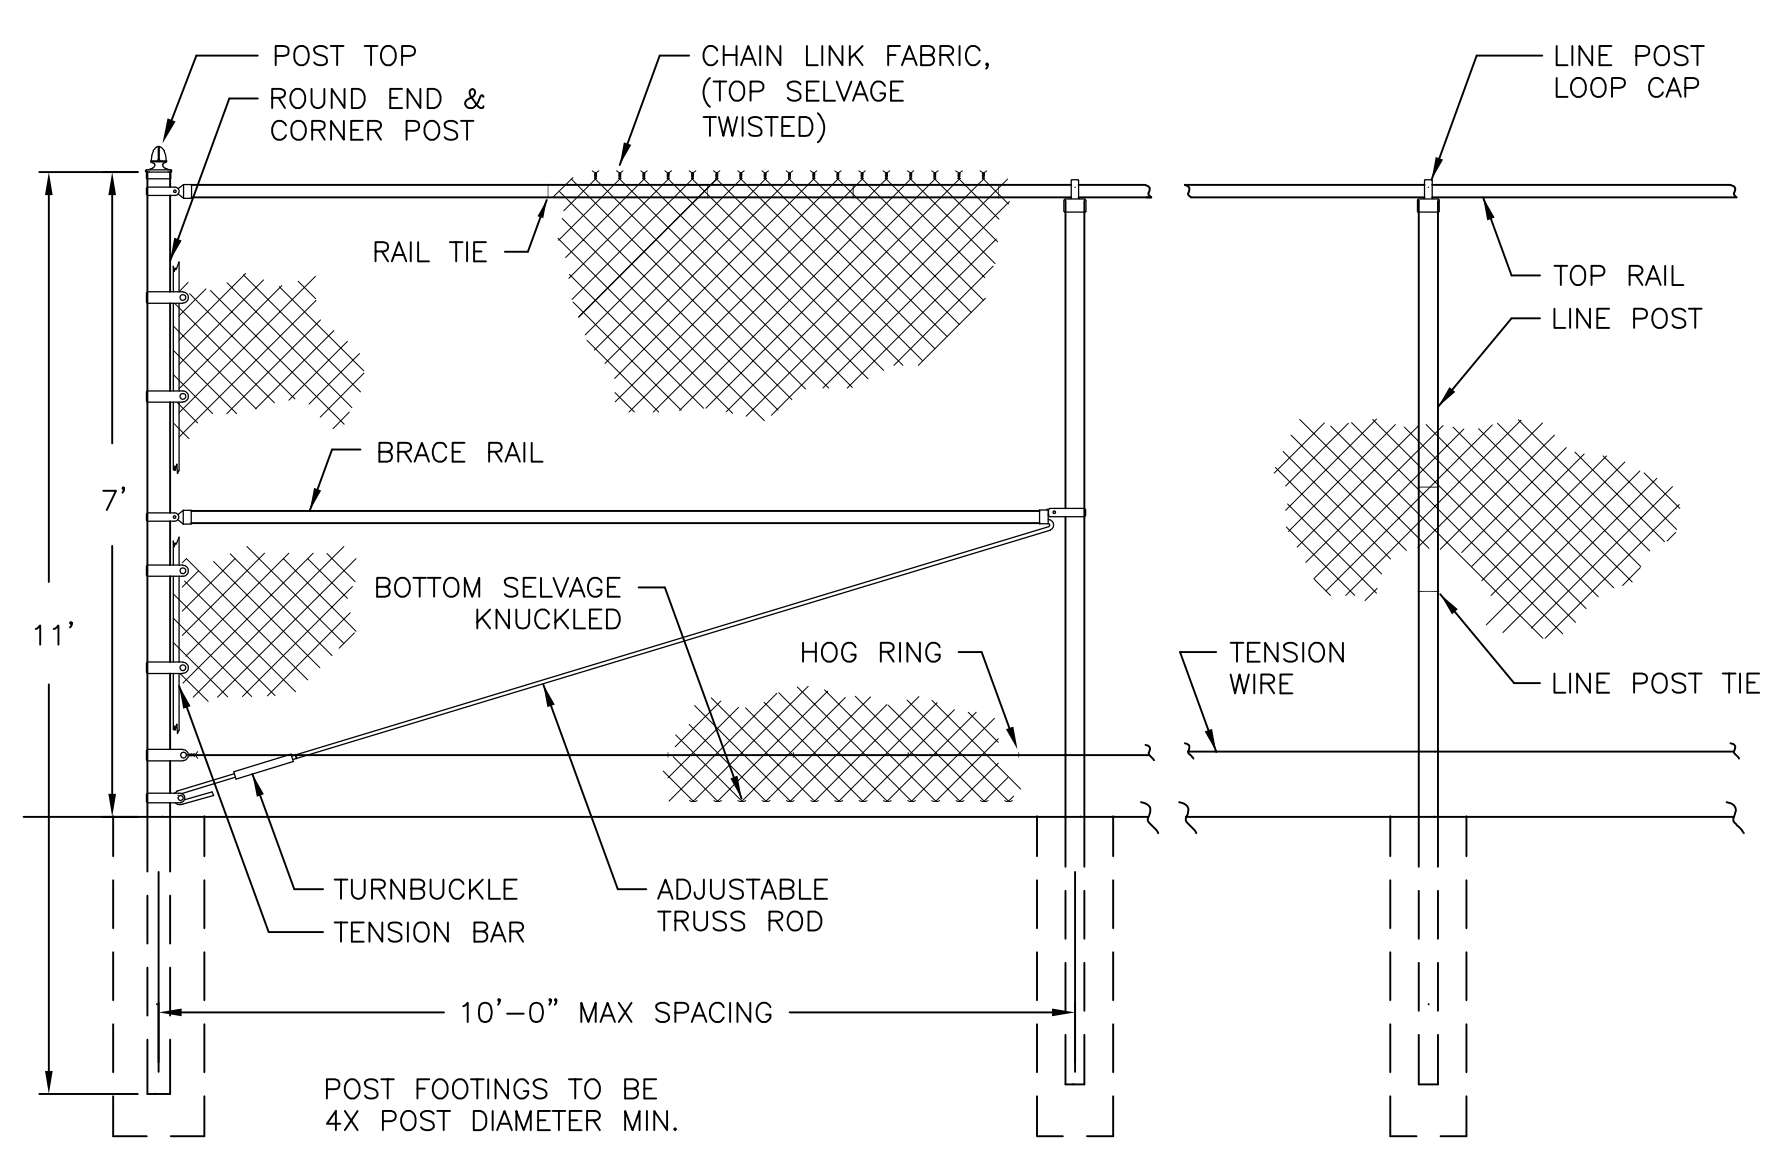
1 FARMLAND SOILS MAP
C200 1" = 200'




2 GRAVEL DRIVE DETAIL
C200 N.T.S.




3 SOLAR ARRAY SIDE VIEW
C200 N.T.S.

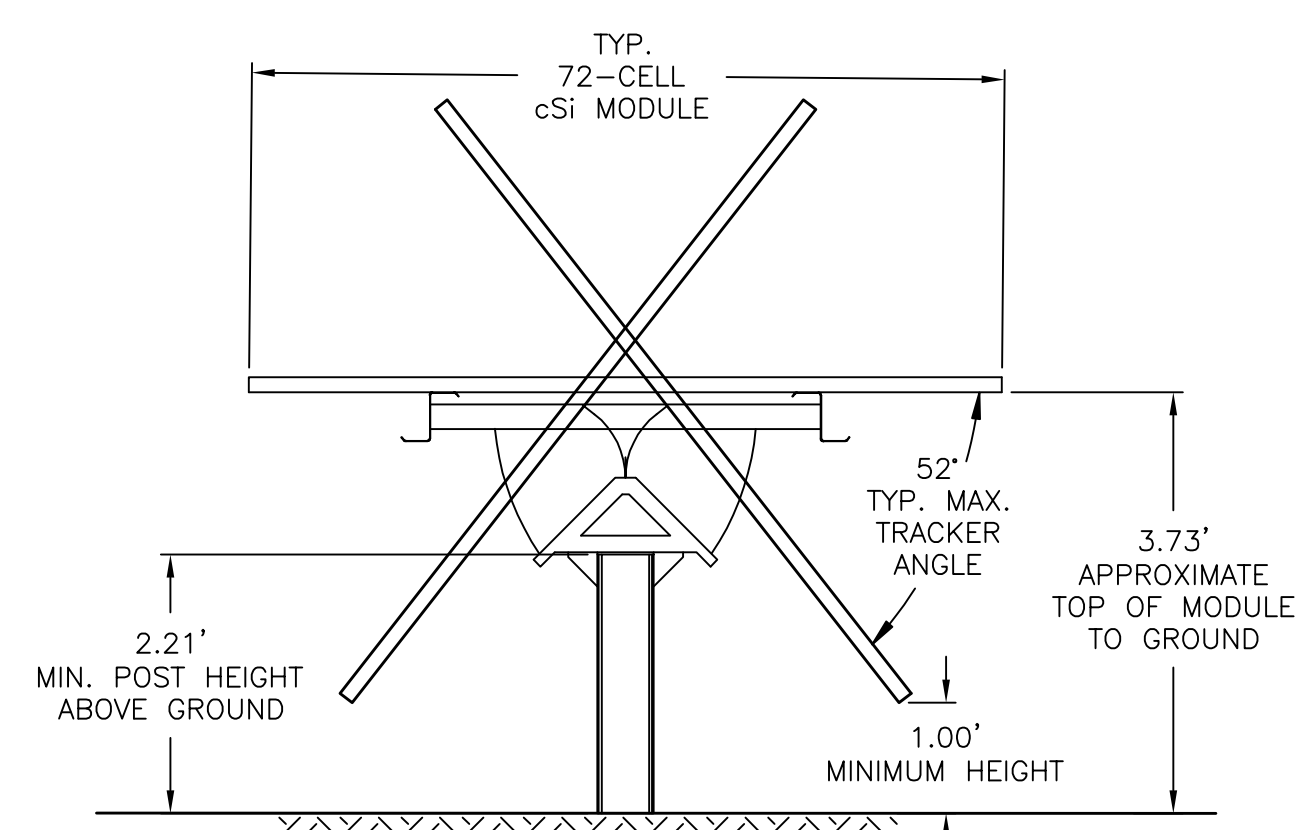

4 CHAIN LINK FENCE DETAIL
C200 N.T.S.

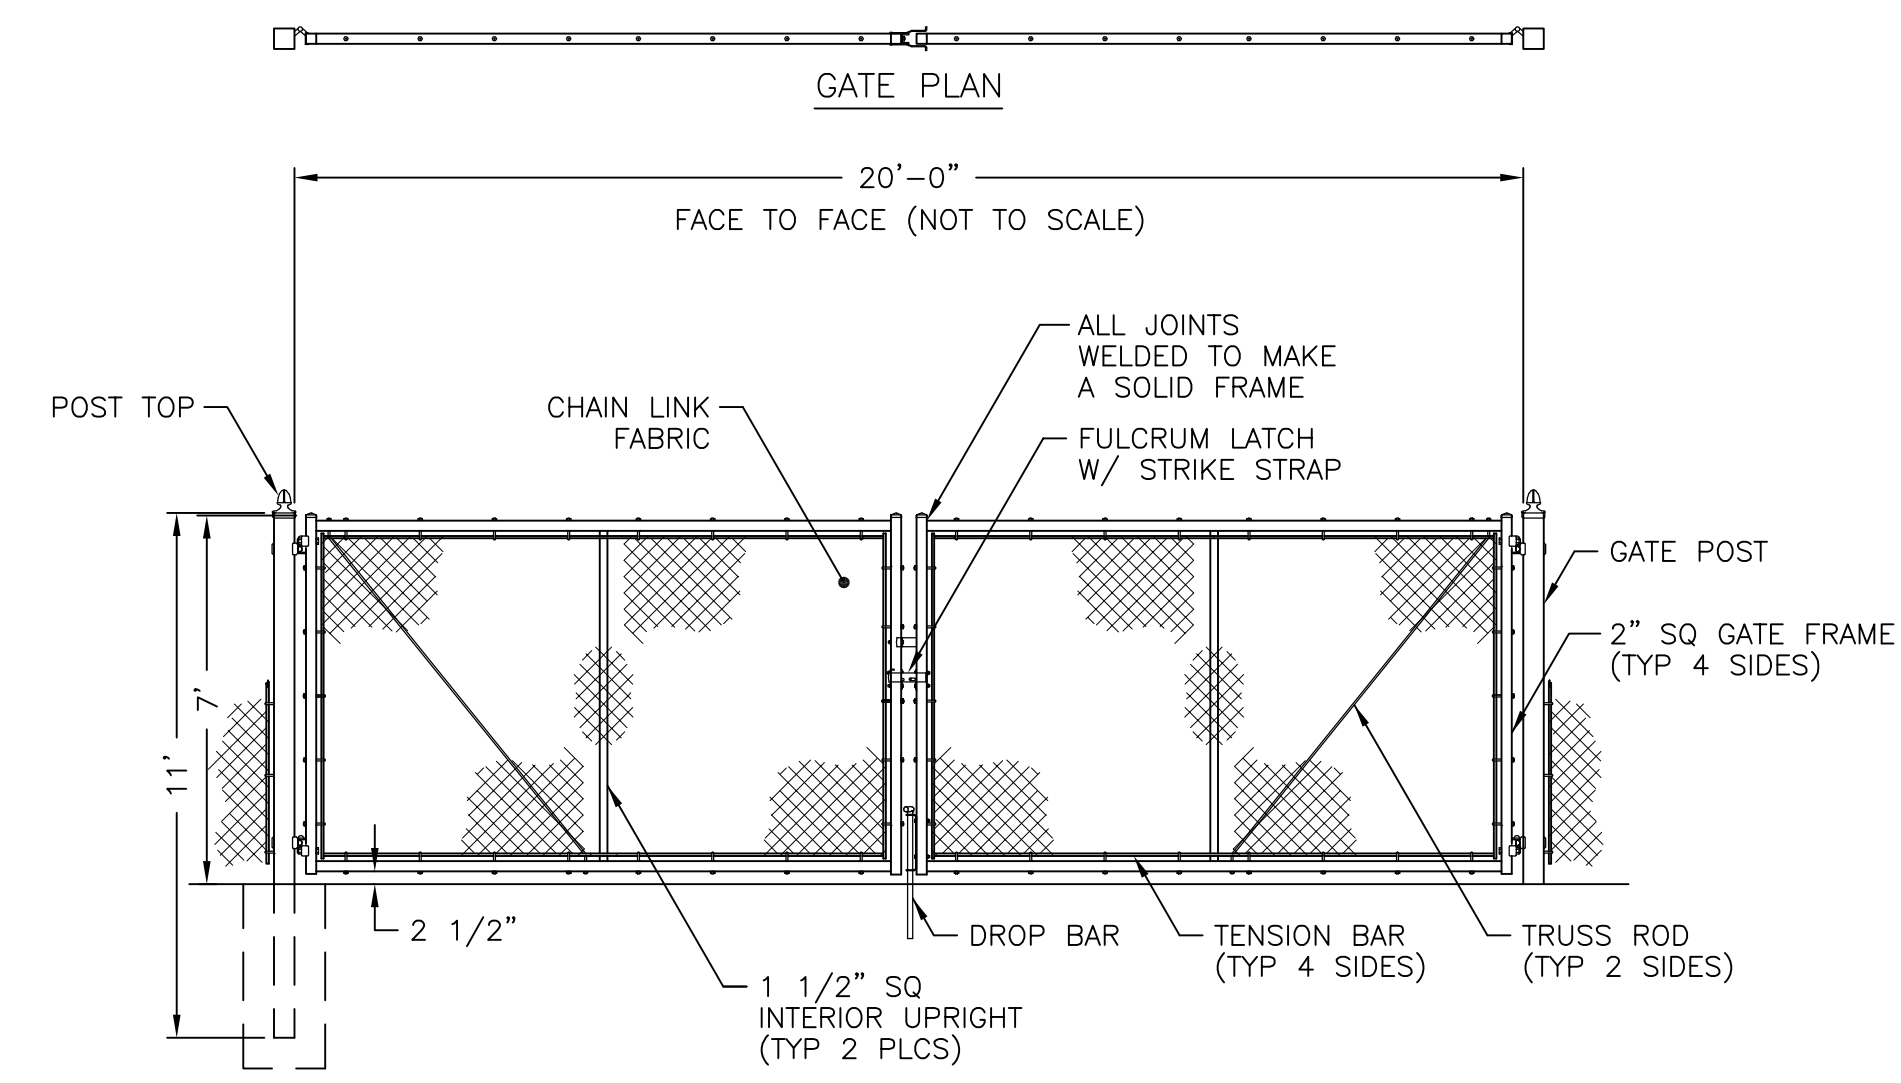

5 CHAIN LINK SWING GATE
C200 N.T.S.

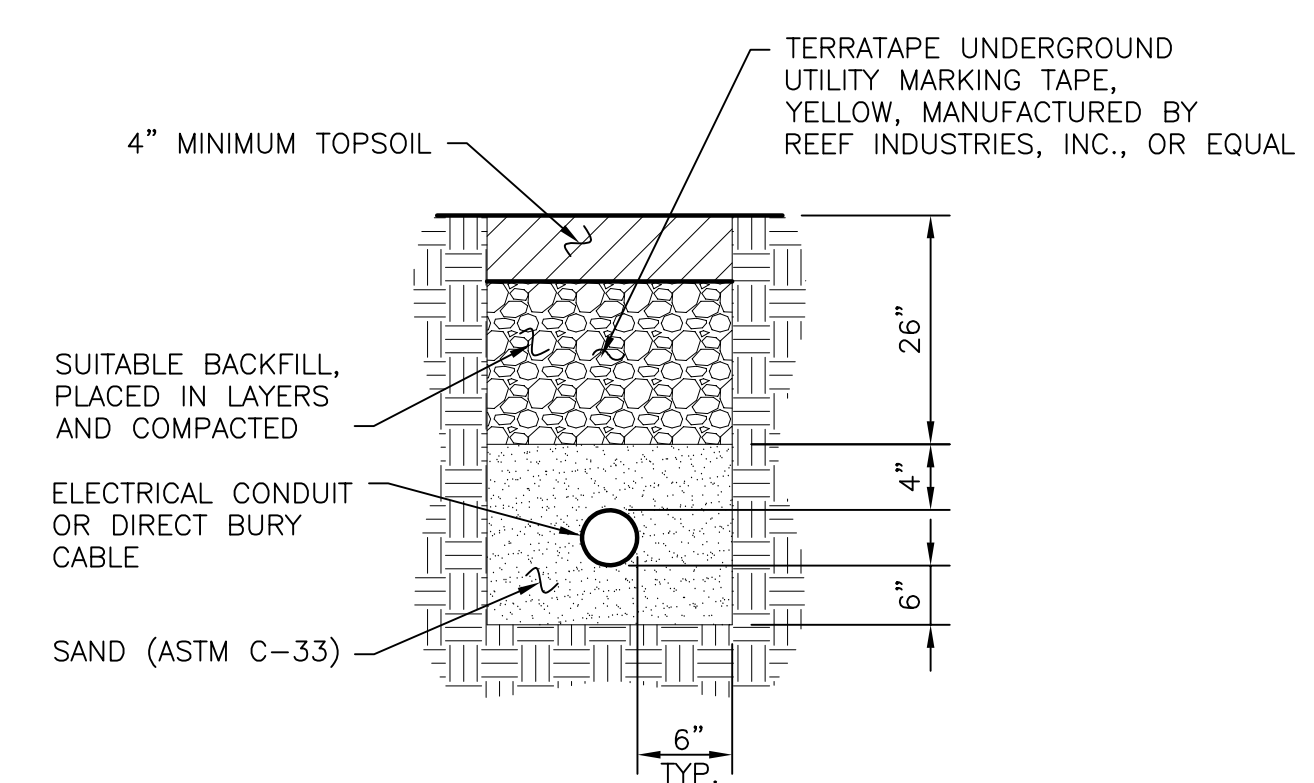


6 ELECTRICAL TRENCH DETAIL
C200 N.T.S.

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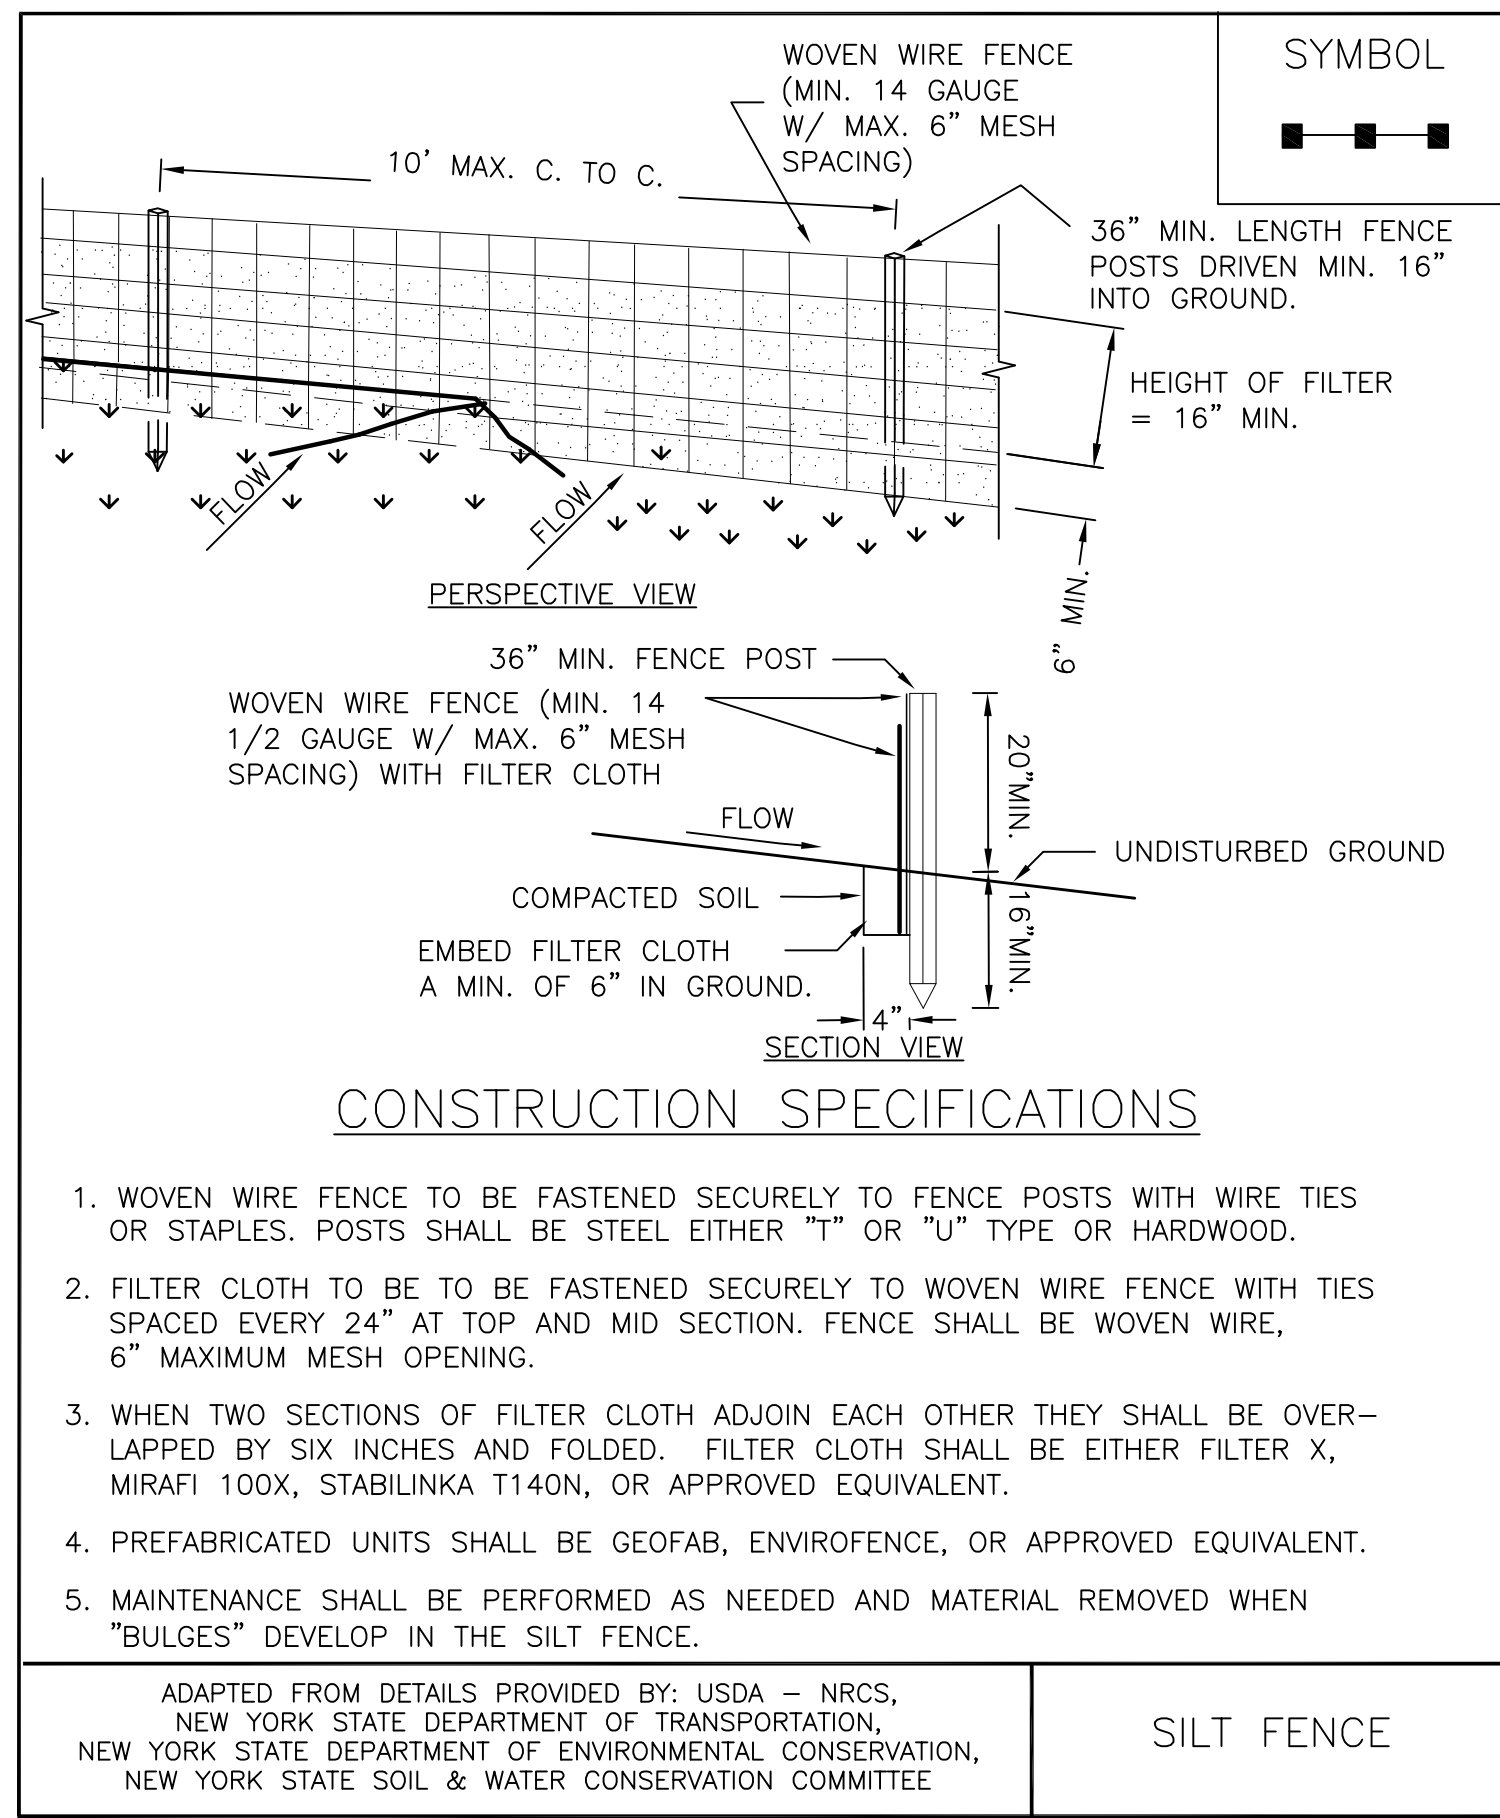
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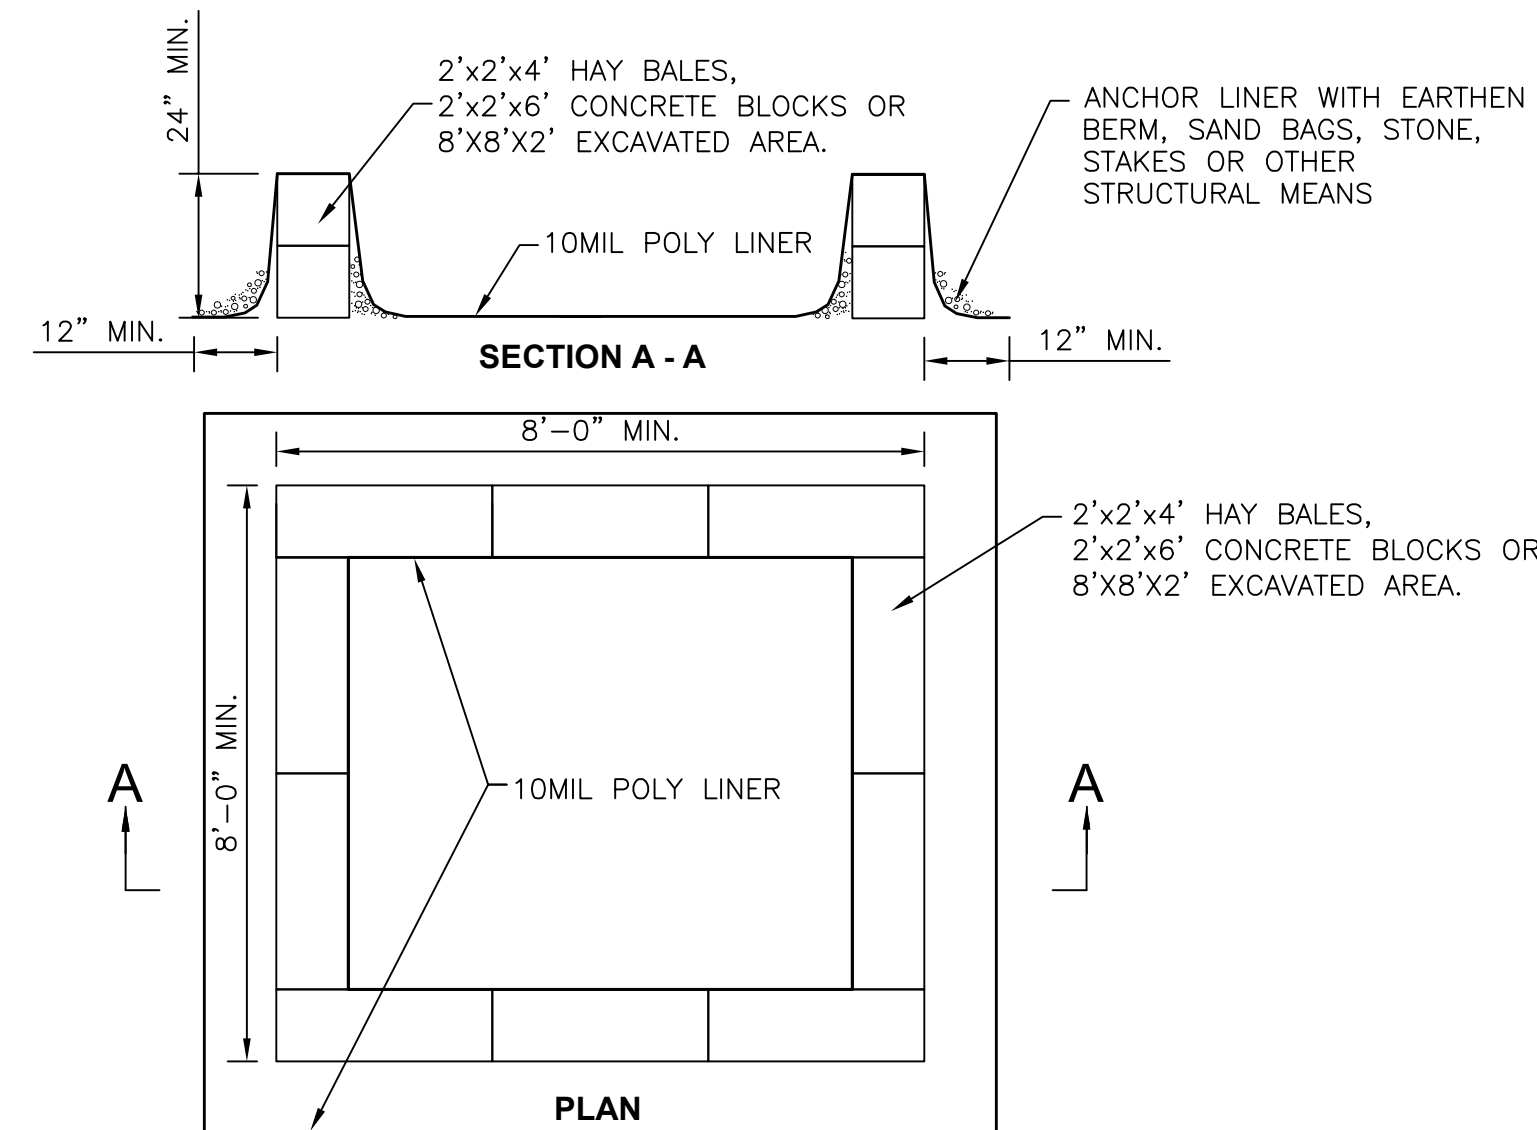
<p>SOLAR ARRAY PLAN CORTLAND-VIRGIL ROAD SOLAR 301 SOUTH CORTLAND VIRGIL ROAD TOWN OF CORTLANDVILLE CORTLAND COUNTY, NY</p>	<p>FARMLAND SOILS AND DETAILS</p>
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<p>DATE: 12/18/18</p>	
<p>CAD FILE NO.: 285024418_6_Site.dwg</p>	



1 STABILIZED CONSTRUCTION ACCESS
C210 N.T.S.

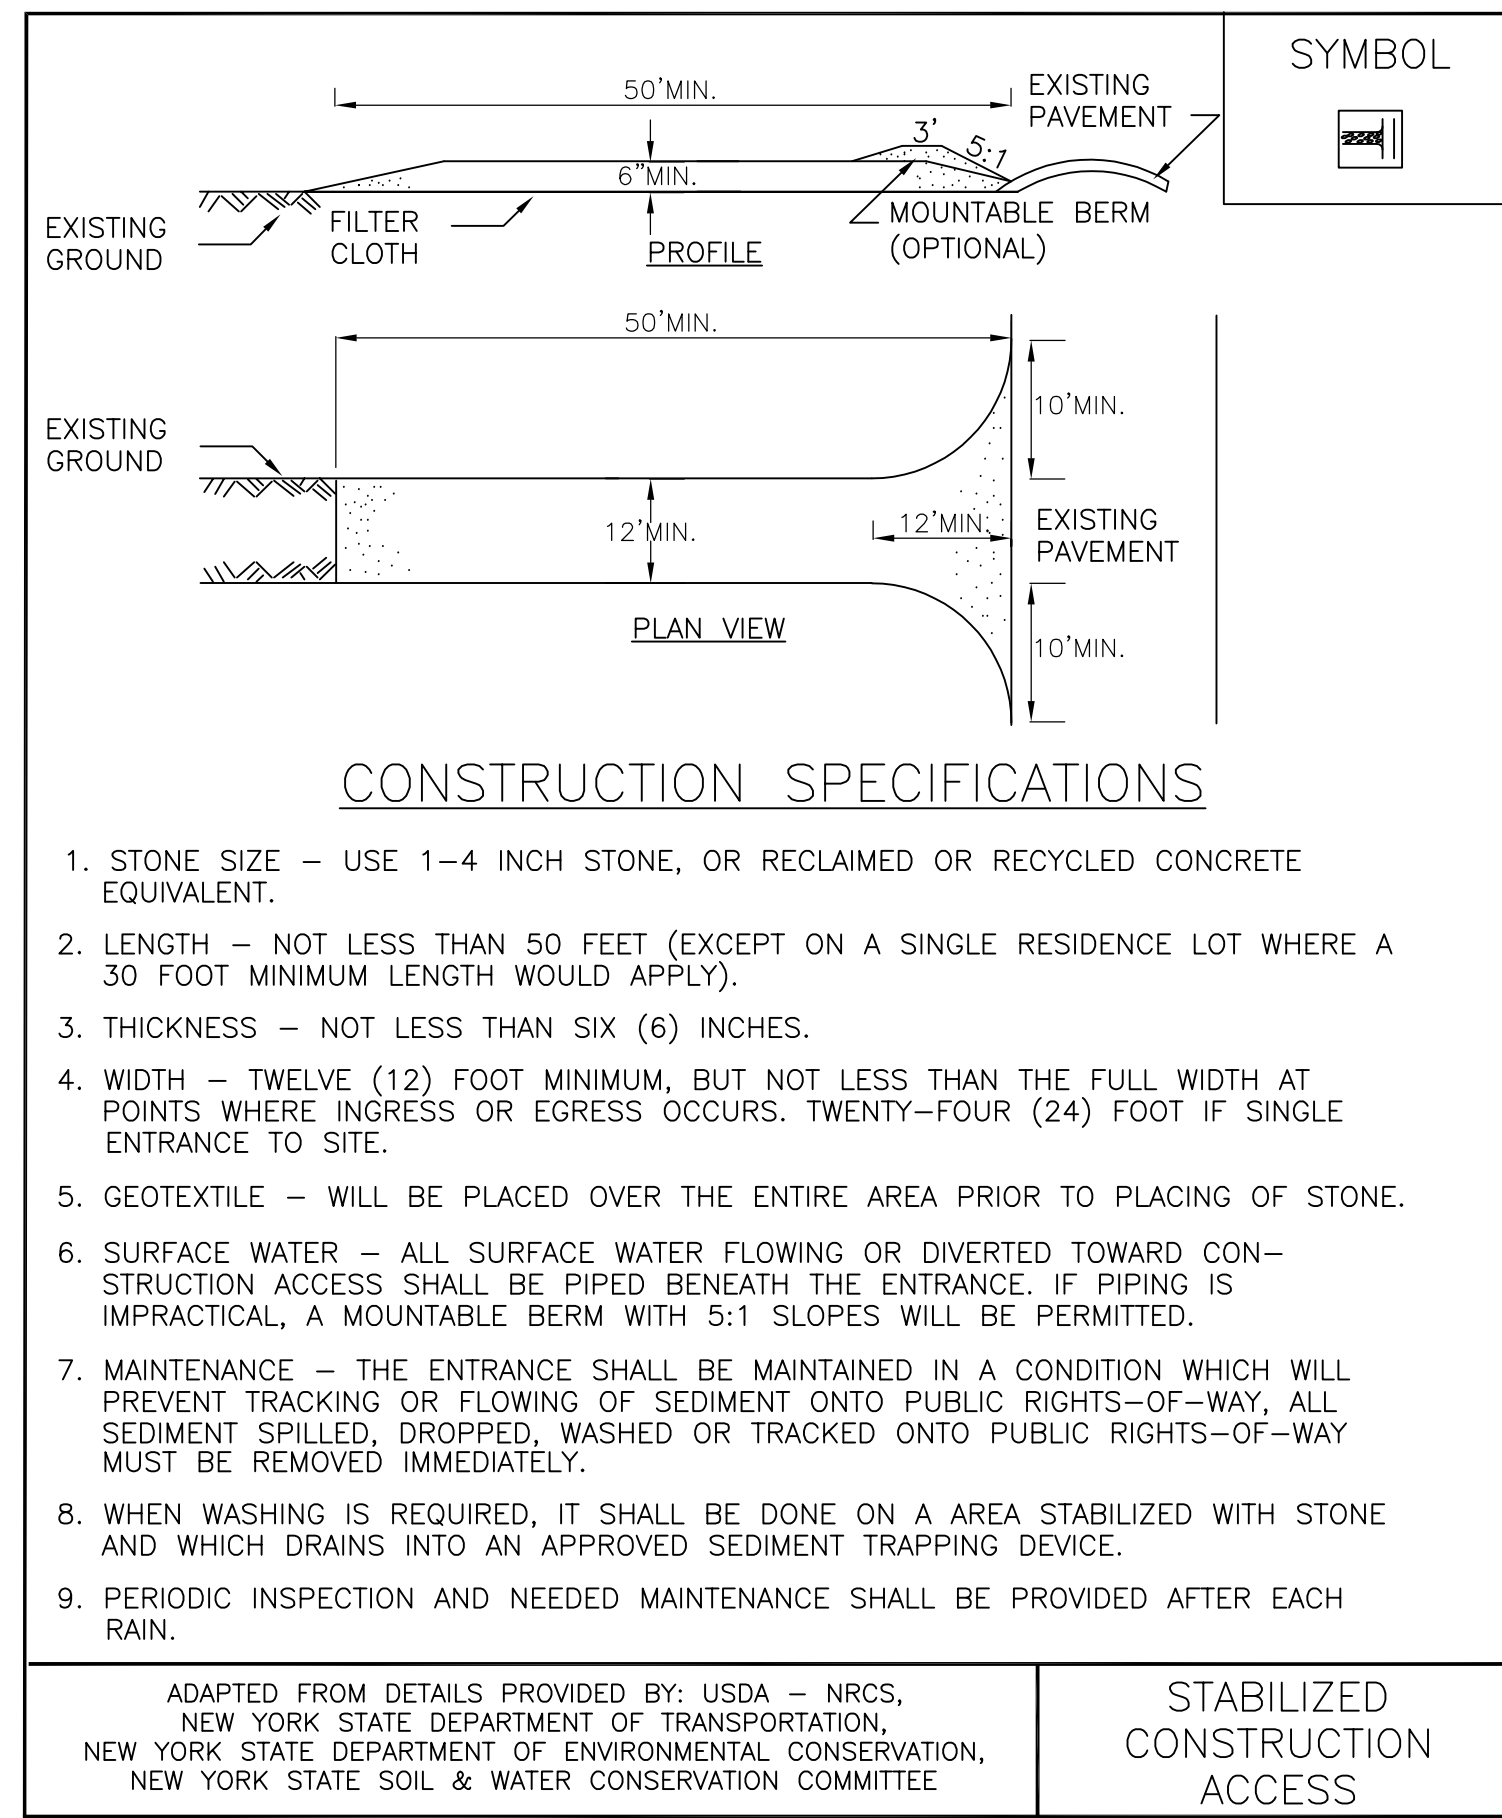

2 SILT FENCE
C210 N.T.S.



NOTES:

- ACTUAL ABOVE GROUND OR EXCAVATED LAYOUT DETERMINED IN FIELD.
- LOCATE THE FACILITY A MINIMUM OF 100' FROM DRAINAGE SWALES, STORM DRAIN INLETS, WETLANDS, STREAMS AND OTHER SURFACE WATERS. WASH WATER SHALL NOT BE ALLOWED TO INFILTRATE INTO SOIL OR ENTER SURFACE WATERS. EXCESS RAINWATER SHALL BE PUMPED TO A STABILIZED AREA SUCH AS A GRASSED FILTER STRIP.
- EXCAVATED WASHOUT STRUCTURES SHALL BE A MINIMUM OF 2' DEEP WITH SIDE SLOPES OF 2:1.
- PROVIDE APPROPRIATE ACCESS TO THE STRUCTURE.
- SIGNS SHALL BE INSTALLED TO DIRECT DRIVERS TO THE CONCRETE WASHOUT LOCATION.
- ALL WASHOUT FACILITIES WILL BE LINED. THE LINER SHALL BE PLASTIC SHEETING WITH A MINIMUM THICKNESS OF 10 MILS WITH NO HOLES OR TEARS. LINER SHALL BE REPLACED WITH EACH CLEANING OF STRUCTURE.
- ALL CONCRETE WASHOUT FACILITIES SHALL BE INSPECTED DAILY. DAMAGED OR LEAKING STRUCTURES SHALL BE DEACTIVATED AND REPAIRED OR REPLACED IMMEDIATELY.
- ACCUMULATED HARDENED MATERIAL SHALL BE REMOVED WHEN 75% OF STORAGE CAPACITY OF THE STRUCTURE IS FILLED. THE MATERIAL SHALL BE DISPOSED OF IN A LEGAL MANNER.
- INSPECT THE PROJECT SITE FREQUENTLY TO ENSURE THAT NO CONCRETE DISCHARGES ARE TAKING PLACE IN NON-DESIGNATED AREAS.

4 CONCRETE WASHOUT STRUCTURE
C210 N.T.S.

EROSION CONTROL NOTES:

- THE SOIL EROSION AND WATER POLLUTION CONTROL DEVICES AS SHOWN ON THE DRAWINGS ARE MINIMUM REQUIREMENTS. THE OWNER'S REPRESENTATIVE MAY REQUIRE ADDITIONAL MEASURES (OR DELETION OF MEASURES) DURING CONSTRUCTION.
- ALL NECESSARY PRECAUTIONS SHALL BE TAKEN TO PREVENT CONTAMINATION OF WATER BY SILT, SEDIMENT, FUELS, SOLVENTS, LUBRICANTS, EPOXY COATINGS, CONCRETE LEACHATE, OR ANY OTHER POLLUTANT ASSOCIATED WITH CONSTRUCTION AND CONSTRUCTION PROCEDURES.
- DURING CONSTRUCTION, NO WET OR FRESH CONCRETE OR LEACHATE SHALL BE ALLOWED TO ESCAPE INTO THE WATERS OF NEW YORK STATE, NOR SHALL WASHINGS FROM CONCRETE TRUCKS, MIXERS, OR OTHER DEVICES BE ALLOWED TO ENTER ANY WETLAND OR WATERS.
- THE SEQUENCE OF OPERATIONS SHOULD ALLOW FOR REGRADING AS CLOSE AS POSSIBLE TO FINAL GRADE. EVERY EFFORT SHALL BE MADE TO PROVIDE ESTABLISHMENT OF FINAL TURF IMMEDIATELY AFTER FINAL GRADING SO AS NOT TO LEAVE DISTURBED AREAS EXPOSED TO RAIN OR DRY/WINDY CONDITIONS.
- IF CONSTRUCTION ACTIVITIES ARE DISCONTINUED IN AREAS OF SOIL DISTURBANCE FOR A PERIOD OF 14 DAYS OR MORE, THE AREA SHALL ALSO BE SEEDED AND MULCHED AS DIRECTED BY ENGINEER WITH A TEMPORARY COVER USING A QUICK GROWING SPECIES (RYEGRASS, ITALIAN RYEGRASS, OR CEREAL GRASSES) SUITABLE FOR THE AREA.
- TEMPORARY SOIL EROSION AND WATER POLLUTION CONTROL DEVICES SHALL BE CLEANED BI-WEEKLY AS A MINIMUM, AFTER ANY STORM AND AS DIRECTED BY ENGINEER. INSPECTION OF ALL DEVICES SHALL BE MADE DAILY AND DEFICIENCIES CORRECTED THAT DAY.
- ALL CONTROLS SHALL BE PLACED PRIOR TO STARTING EARTHWORK OPERATIONS AND IN ACCORDANCE WITH FEDERAL, STATE, LOCAL AND MANUFACTURES RECOMMENDATIONS. THE CONTRACTOR SHALL PLACE AND MAINTAIN ALL EROSION CONTROL DEVICES AS NEEDED THROUGHOUT THE PROJECT.
- CONTRACTOR SHALL MAINTAIN A DUMPSTER ON-SITE FOR THE DISPOSAL OF CONSTRUCTION DEBRIS AND THIS DUMPSTER SHALL BE SERVICED AS NEEDED TO PREVENT ANY WASTE CONSTRUCTION MATERIALS FROM CLUTTERING THE JOB SITE.
- CONTRACTOR SHALL COMPLY WITH NYSDEC, GP-0-15-002, SPDES, GENERAL PERMIT REQUIREMENTS IF APPLICABLE.
- PRIOR TO CONSTRUCTION EQUIPMENT ENTERING OR EXITING THE SITE, A CONSTRUCTION ENTRANCE SHALL BE BUILT UNLESS EXISTING CONDITIONS PREVENT ANY TRACKING OF DIRT, MUD, OR DEBRIS OFF THE SITE. THE CONTRACTOR WILL BE RESPONSIBLE TO KEEP ALL ROADS CLEAN. THIS WILL INCLUDE BUILDING THE CONSTRUCTION ENTRANCE, SWEEPING, SCRAPING AND WASHING THE PAVEMENT SURFACES WHENEVER NEEDED. THE CONSTRUCTION ENTRANCE SHALL BE CONSTRUCTED AS SHOWN ON THE PLANS. THE ENTRANCE SHOULD BE LOCATED SO THAT ALL VEHICLES LEAVING THE SITE WILL UTILIZE IT.
- ALL EROSION CONTROL DEVICES SHALL BE PLACED AS SHOWN ON THE DRAWINGS AND IN ACCORDANCE WITH FEDERAL, STATE, LOCAL AND MANUFACTURES RECOMMENDATIONS. THE CONTRACTOR SHALL PLACE AND MAINTAIN ALL EROSION CONTROL DEVICES AS NEEDED THROUGHOUT THE PROJECT.
- TEMPORARY SEEDING SHALL CONSIST OF LIME @ 1/2 TON PER ACRE, FERTILIZER 5-10-10 @ 600 POUNDS PER ACRE, RYEGRASS (ANNUAL OR PERENNIAL) @ 40 POUNDS PER ACRE AND STRAW MULCH @ 2 TON PER ACRE. JUTE MESH SHALL BE PLACED OVER MULCH AND STAKED WHENEVER WINDS OR SLOPE WILL CAUSE THE MULCH AND SEED TO BECOME DEPLETED OR ERODED. AREAS SHALL BE TEMPORARY SEEDED WHEN THEY ARE SUBJECT TO EROSION AND WILL LIE DORMANT FOR A MONTH OR MORE.

SEEDING

- SEED, MULCH AND FERTILIZE AS NECESSARY TO RESTORE ALL DISTURBED AREAS TO ORIGINAL CONDITION OR BETTER.
- WHEN PLACING BY HYDROSEEDING APPLICATION SEED SHALL BE PLACED AT 80 POUNDS PER ACRE, HYDROMULCH AT 1,200 POUNDS PER ACRE, WATER AT 500 GALLONS PER ACRE AND FERTILIZER AT A MINIMUM OF 220 POUNDS PER ACRE.
- IF PLACING BY MECHANICAL MEANS FERTILIZER SHALL BE PLACED AT 25 POUNDS PER 1,000 SQUARE FEET, SEED AT 5 POUNDS PER 1,000 SQUARE FEET AND STRAW MULCH AT 2 TONS PER ACRE. PLACE FERTILIZER AND SEED THEN LIGHTLY RAKE AND THEN ROLL WITH 200 POUND ROLLER. MULCH THE AREA THEN WATER. STRAW MAY NEED TO BE SECURE TO PREVENT IT BLOWING AWAY.

NOT FOR CONSTRUCTION

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NO.	REVISIONS AND DESCRIPTIONS	DATE
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SOLAR ARRAY PLAN
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301 SOUTH CORTLAND VIRGIL ROAD
TOWN OF CORTLANDVILLE
CORTLAND COUNTY, NY

DETAILS

SHEET NO.
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