2020 NY GREENFIELD PV DESIGN - RILEY ROAD

1902 RILEY RD, CORTLAND, NY 13045

PROJECT DATA

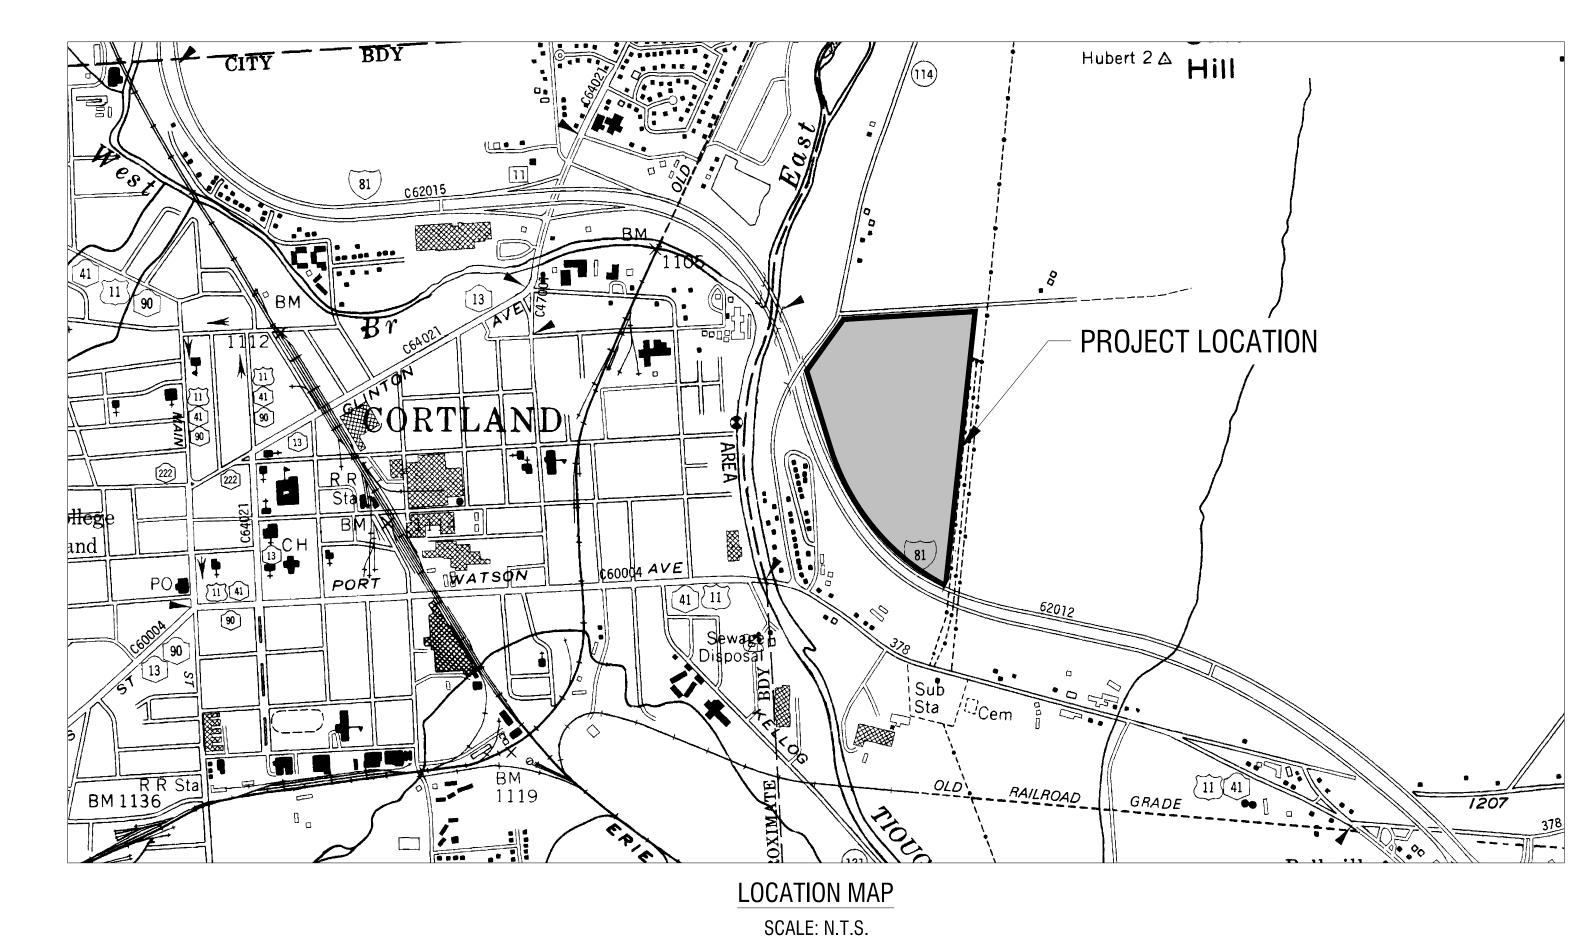
APPLICANT	NEXT ERA ENERGY			
PARCEL ADDRESS	1902 RILEY RD, CORTLANDVILLE, NY 13045			
TAX NUMBER	87.00-03-08.112			
GPS COORDINATES	N: 42.604164° W: -76.153672°			
AVERAGE SITE ELEVATION	1275.00'			
PARCEL AREA	52.05 ACRES			
DISTURBANCE AREA	35.8 ACRES			
EQUIPMENT PAD AREA	±11,400 SF			
STAGING AREA	0.63 ACRES			
FENCED AREA	34.24 ACRES			
DRIVEN POST CROSS SECTIONAL AREA	±2 SF			
DRIVEN POST QUANTITY	4,035			
DRIVEN POST CROSS SECTIONAL AREA (TOTAL)	12,676.3 SF			
ROAD LENGTH	±1,675 FT			
SILT FENCE	±2,090 FT			
CHAIN LINK FENCE	± 5,190 FT			
GATE COUNT	2			

SYSTEM SUMMARY (TOTAL)

	1	
SYSTEM AC SIZE (MW)	5.0	
SYSTEM DC SIZE (MW)	7.5	
MODULE COUNT	20,982	
INVERTER COUNT	X	
SWITCH GEAR COUNT	Х	
TRANSFORMER COUNT	X	
EQUIPMENT PAD COUNT	2	
UTILITY POLE COUNT	6	

ZONING INFORMATION

	REQUIRED	PROPOSED
CODE APPLIED	TOWN OF (CORTLAND
WEBSITE	HTTPS://WWW.CORTLANDVILLE.ORG/ PLANNING-ZONING/PAGES/ZONING-LAWS	
CLASSIFICATION	AGRICULTUR	AL DISTRICT
FRONT SETBACK	75 FT	75 FT
SIDE SETBACK	100 FT	75 FT
REAR SETBACK	75 FT	100 FT
ENTRANCE WIDTH	-	20 FT
MAX FENCE HEIGHT	-	7 FT
STRUCTURE COVERAGE	20%	±19%
MIN LOT SIZE	2 AC	52 05 AC



CIVIL DRAWING INDEX

C000	COVER SHEET	REV 0-0
C001	CONSTRUCTION NOTES	REV 0-0
C101	EXISTING CONDITIONS AND REMOVALS PLAN	REV 0-0
C102	EXISTING CONDITIONS AND REMOVALS PLAN	REV 0-0
C200	OVERALL SITE PLAN	REV 0-0
C201	SITE PLAN	REV 0-0
C202	SITE PLAN	REV 0-0
C501	EROSION & SEDIMENT CONTROL PLAN	REV 0-0
C502	EROSION & SEDIMENT CONTROL PLAN	REV 0-0
C601	LANDSCAPING PLAN	REV 0-0
C602	LANDSCAPING PLAN	REV 0-0
C701	CONSTRUCTION DETAILS	REV 0-0
C702	CONSTRUCTION DETAILS	REV 0-0
C703	CONSTRUCTION DETAILS	REV 0-0
C704	CONSTRUCTION DETAILS	REV 0-0

NEXTERA ENERGY RESOURCES

700 UNIVERSE BLVD.
JUNO BEACH, FL 33408
PROJECT NO: 2201200.08
NOVEMBER 2020





300 State Street, Suite 201 Rochester, NY 14614 585-454-6110 Iabellapc.com

GENERAL GRADING NOTES

- 1. THE CONTRACTOR SHALL CONFORM TO THE REQUIREMENTS OF OSHA, AND ANY OTHER AGENCY HAVING JURISDICTION WITH REGARD TO SAFETY PRECAUTIONS WITH TRENCHING OPERATIONS. THE REQUIREMENTS SET FORTH HEREIN ARE INTENDED TO SUPPLEMENT REQUIREMENTS ESTABLISHED BY THESE AGENCIES. IN THE CASE OF A CONFLICT BETWEEN REQUIREMENTS OF OTHER JURISDICTIONAL AGENCIES AND THESE DOCUMENTS, THE MORE STRINGENT REQUIREMENT ON THE CONTRACTOR SHALL APPLY.
- 2. SHEETING, IF REQUIRED DURING CONSTRUCTION, IS CONSIDERED TO BE PART OF THIS CONTRACT AND SHALL BE PROVIDED AT NO ADDITIONAL COST TO THE OWNER.
- 3. ALL TRENCHES THROUGH PAVEMENT SHALL BE SAW CUT PRIOR TO EXCAVATION AND AGAIN PRIOR TO PAVEMENT RESTORATION.
- 4. CONTRACTOR SHALL ADJUST THE RIMS OF ALL MANHOLES, CATCH BASINS, VALVE BOXES AND OTHER UTILITY SITE STRUCTURES TO MEET FINISHED GRADE IN AREAS REQUIRING REPAVING OR REGRADING AS PART OF THE WORK, INCLUDING THOSE THAT MAY NOT BE SHOWN ON THE PLANS.
- 5. VOIDS LEFT BY UTILITY OR STRUCTURE REMOVAL OR GRUBBING OPERATIONS SHALL BE BACKFILLED AND PROPERLY COMPACTED WITH STRUCTURAL FILL (NYSDOT ITEM 304.12) IN AREAS UNDER AND WITHIN 5 FEET HORIZONTALLY OF ALL STRUCTURES, BUILDINGS AND PAVEMENTS. IN GRASSED AREAS, VOIDS LEFT SHALL BE FILLED AND PROPERLY COMPACTED WITH SUITABLE ON-SITE OR IMPORTED EARTHEN BACKFILL. ALL DISTURBED AREAS SHALL BE RESTORED.
- 6. THE CONTRACTOR SHALL DEWATER ALL EXCAVATIONS TO PREVENT THE INTRODUCTION OF GROUNDWATER INTO THE TRENCHES/EXCAVATIONS. PROVIDE ALL EQUIPMENT NECESSARY TO MAINTAIN THE GROUNDWATER LEVEL AS NECESSARY
- 7. THE CONTRACTOR SHALL PLACE AT A MINIMUM 6 INCHES OF MECHANICALLY CLEANED SCREENED TOPSOIL, FREE OF ANY ROOTS, CLAY CLUMPS, ROCKS LARGER THAN 1", AND OTHER FOREIGN MATTER IN ALL DISTURBED AREAS PRIOR TO SEEDING.
- 8. ANY DISCREPANCIES BETWEEN THE CONTRACTORS SURVEY STAKEOUT AND THE ENGINEER'S DESIGN INTENT OR DETAILS SHALL BE BROUGHT TO THE ENGINEERS ATTENTION PRIOR TO INSTALLATION. FAILURE TO DO SO WILL NOT RESULT IN ADDITIONAL COSTS TO THE OWNER.

TEMPORARY SEEDING NOTES

- 1. IF SPRING OR SUMMER OR EARLY FALL, THEN SEED THE AREA WITH RYEGRASS (ANNUAL OR PERENNIAL) AT 30 LBS. PER ACRE
- 2. IF LATE FALL OR EARLY WINTER, THEN SEED DERTIFIED 'AROOSTOOK' WINTER RYE (CERAL RYE) AT 100 LBS PER ACRE.
- 3. FERTILIZER OR LIME ARE NOT TYPICALLY USED FOR TEMPORARY SEEDING, BUT IF USED SHOULD BE IN ACCORDANCE WITH THE PERMANENT SEEDING NOTES ON THE LANDSCAPE PLAN.
- 4. ANY SEEDING METHOD MAY BE USED THAT WILL PROVIDE UNIFORM APPLICATION OF SEED TO THE AREA AND RESULT IN RELATIVELY GOOD SOIL TO SEED CONTACT.
- 5. MULCH THE AREA WITH HAY OR STRAW AT 2 TONS PER ACRE (4 TONS PER ACRE IN WINTER). QUALIFY OF HAY OR STRAW MULCH ALLOWABLE WILL BE DETERMINED BASED ON LONG TERM USE AND VISUAL CONCERNS. MULCH ANCHORING WILL BE REQUIRED WHERE WIND OR AREAS OF CONCENTRATED WATER ARE OF CONCERN.

BASEMAP INFORMATION				
PART OF BASEMAP	RECIEVED FROM	DATE		
WETLAND DELINEATION	NEXT ERA ENERGY SOURCES	JULY 3, 2020		
LEGAL DESCRIPTION	CHICAGO TITLE INSURANCE COMPANY	APRIL 14, 2020		
TOPOGRAPHIC SURVEY	NEXT ERA ENERGY RESOURCES	JULY 3, 2020		
BOUNDARY SURVEY	SCHWERZLER LAND SURVEYING, LLC	JULY 6, 2020		
TREE LINES	TRACED FROM AERIAL IMAGGERY	JULY 6, 2020		

GENERAL NOTES

- 1. THE CONTRACTOR ALONE SHALL BE RESPONSIBLE TO LOCATE UTILITIES OUTSIDE THE RIGHT-OF-WAY INCLUDING PRIVATE ROADS.
- 2. SITE DRAINAGE, INCLUDING THE PROJECT SITE AND ADJACENT PRIVATE AND PUBLIC ROADWAYS, DRIVES, PARKING AREAS OR PROPERTIES SHALL BE MAINTAINED THROUGHOUT THE CONSTRUCTION PERIOD.
- 3. THE CONTRACTOR SHALL BE RESPONSIBLE FOR SUPPLYING ALL MATERIALS, TOOLS AND EQUIPMENT, INCLUDING SPECIAL CUTTING DEVICES, NECESSARY TO PERFORM THE WORK CONTAINED IN THIS CONTRACT.
- 4. THE SIZES AND MATERIAL OF CONSTRUCTION OF WATER MAINS, SANITARY SEWERS AND STORM SEWERS TO REMAIN ARE REPUTED. THE CONTRACTOR SHALL VERIFY SIZES OF ALL UTILITIES WHERE CONNECTIONS TO SAID EXISTING UTILITIES ARE REQUIRED. EXCAVATION TO VERIFY THESE UTILITIES SHALL BE MADE AT NO ADDITIONAL COST TO THE OWNER.
- 5. THE CONTRACTOR SHALL PROTECT ALL EXISTING SITE AMENITIES NOT DESIGNATED FOR REMOVAL.
- 6. UNLESS OTHERWISE INDICATED ON THE PLANS OR DIRECTED BY THE ARCHITECT/ENGINEER, THE CONTRACTOR IS RESPONSIBLE FOR PRESERVING AND PROTECTING FROM DAMAGE ALL TREES, SHRUBS AND PLANTS IN THE VICINITY OF THE PROPOSED WORK.
- 7. THE CONTRACTOR SHALL PROTECT AND SUPPORT ALL EXISTING UTILITIES DESIGNATED TO REMAIN FOR THE DURATION OF THE CONTRACT.
- 8. ANY SITE AMENITY, UTILITY, STREET APPURTENANCE, OR OTHER ITEM WHICH BECOMES DAMAGED AS A RESULT OF THE CONTRACTOR'S OPERATIONS SHALL BE REPAIRED OR REPLACED IN-KIND BY THE CONTRACTOR AS DETERMINED BY THE PROJECT MANAGER OR ARCHITECT/ENGINEER AND AT NO ADDITIONAL COST TO THE OWNER.

SURVEY NOTES

- 1. CONTRACTOR SHALL FIELD VERIFY ALL EXISTING CONDITIONS PRIOR TO BID. NO ALLOWANCE WILL BE MADE FOR ADDITIONAL COSTS DUE TO CONTRACTOR'S FAILURE TO VERIFY EXISTING CONDITIONS.
- 2. THE CONTRACTOR SHALL LOCATE, MARK, SAFEGUARD AND PRESERVE ALL SURVEY MARKERS AND RIGHT-OF-WAY MARKERS IN THE AREA OF CONSTRUCTION.
- 3. ANY IRON PINS, MONUMENTS OR OTHER ITEMS DEFINING PROPERTY LINES WHICH ARE DISTURBED BY CONSTRUCTION OPERATIONS SHALL BE PROPERLY TIED AND ACCURATELY RESET BY A NYS LICENSED SURVEYOR UPON COMPLETION OF THE WORK
- 4. THE VERTICAL DATUM IS REFERENCED TO NORTH AMERICAN VERTICAL DATUM 88 (NAVD 88).
- 5. THE HORIZONTAL DATUM IS REFERENCED TO NORTH AMERICAN DATUM 83 (NAVD 83) STATE PLANE NEW YORK CENTRAL.

RESTORATION NOTES

- 1. A SOILS ANALYSIS SHALL BE COMPLETED PRIOR TO APPLYING ANY FERTILIZER OR SOIL AMENDMENT TO ENSURE THE PROPER MIX IS
- 2. SLOW-RELEASE FERTILIZER: GRANULAR OR PELLETED FERTILIZER CONSISTING OF 50 PERCENT WATER- INSOLUBLE NITROGEN, PHOSPORUS, AND POTASSIUM IN THE FOLLOWING COMPOSITION.

 COMPOSITION: 10 PERCENT NITROGEN, 6 PERCENT PHOSPHOROUS, 4 PERCENT POTASSIUM, BY WEIGHT.
- 3. CYANAMID COMPOUNDS AND HYDRATED LIME ARE NOT PERMITTED IN FERTILIZER MIXTURES.
- 4. FERTILIZER IS NOT REQUIRED FOR TEMPORARY SEED.
- 5. STRAW MULCH: CLEAN, MILDEW- AND SEED FREE OAT OR WHEAT STRAW WELL SEASONED BEFORE BALING, FREE FROM MATURE SEED BEARING STALKS OR ROOTS OF PROHIBITED OR NOXIOUS WEEDS.
- 6. HYDRO FIBER MULCH: SHALL BE A WOOD FIBER OR WOOD FIBER AND CELLULOSE MIXTURE, PROVIDING THE CELLULOSE CONTENT DOES NOT EXCEED 20% BY VOLUME AND IS THOROUGHLY MIXED WITH WOOD FIBER MULCH. APPLY LIQUID TACKIFIER UNIFORMLY AT THE RATE OF 60 GALLONS PER ACRE, TO KEEP STRAW MULCH IN PLACE.
- 7. PERMANENT SEED SPECIES: REFER TO SPECIFICATIONS, PROVIDE STATE-CERTIFIED (BLUE TAG) SEED OF GRASS SPECIES AND PERCENTAGES
- 8. SLOPE STABILIZATION MESH STABILIZATION FABRIC SHALL BE ADDED ON ALL SLOPES EXCEEDING ONE FOOT VERTICAL TO THREE FEET HORIZONTAL (1 ON 3).
- 9. ALL DISTURBED SOILS LOCATED IN LAWN AREAS ARE TO BE TILLED A MINIMUM OF 12" IN ORDER TO RESTORE THE ORIGINAL PROPERTIES OF THE SOIL

SCHEDULE OF CONSTRUCTION ACTIVITIES

- 1. SCHEDULE A PRE-CONSTRUCTION MEETING WITH TOWN OFFICIALS, OWNER, EMERGENCY SERVICES, UTILITY & OTHER AGENCIES IN ATTENDANCE.
- 2. SUBMIT EROSION CONTROL MEASURES AND SEQUENCING FOR REVIEW AND APPROVAL BY THE QUALIFIED INSPECTOR
- 3. INSTALL STABILIZED CONSTRUCTION ENTRANCE.
- 4. INSTALL CONSTRUCTION AREA, DESIGNATED TOPSOIL STOCKPILE AREA, AND STAGING AREA FENCING.
- 5. INSTALL PERIMETER SEDIMENT CONTROLS, SUCH AS SILT FENCE / SEDIMENT SOCK.
- 6. PROTECT EXISTING VEGETATION AND OTHER ENVIRONMENTAL FEATURES TO BE PRESERVED WITH ORANGE CONSTRUCTION FENCE OR TREE PROTECTION.
- 7. CLEAR AND GRUB BRUSH, SHRUBS, AND OTHER DEBRIS WITHIN DESIGNATED AREAS.
- 8. INSPECT, CLEAN, AND MAINTAIN EROSION CONTROL MEASURES AS NECESSARY AND AS ORDERED BY THE QUALIFIED INSPECTOR. SWEEP PUBLIC OR PRIVATE ROADWAYS, DRIVES AND PARKING AREAS AS NECESSARY TO MAINTAIN CLEAN FROM DEBRIS. RELOCATED AND RESET EROSION CONTROL MEASURES AND CONSTRUCTION FENCING AS REQUIRED TO COMPLETE WORK. ALL APPROPRIATE EROSION AND SEDIMENT CONTROL MEASURES SHALL BE IN PLACE AND FUNCTIONAL BEFORE COMMENCEMENT OF CONSTRUCTION OF ANY SEGMENT OF THE PROJECT THAT REQUIRES SUCH MEASURES.
- 9. STABILIZE DISTURBED AREAS AND STOCKPILES WITHIN 14 DAYS OF LAST CONSTRUCTION ACTIVITY IN EACH AREA. (7 DATS IF GREATER THAN 5 ACRES DISTURBED)
- 10. INSTALL UTILITES. EXCESS MATERIALS NOT BACKFILLED IN UTILITY TRENCHES SHALL BE REMOVED FROM THE SITE OR SPOILED IN AREAS APPROVED BY THE OWNER. EROSION CONTROL MEASURES ARE NOT REQUIRED AROUND SOILS (EARTHEN MATERIALS) EXCAVATED, SIDE CAST AND BACKFILLED INTO THE TRENCH WITHIN THE SAME DAY.
- 11. DEWATER EXCAVATIONS AS NECESSARY. PUMPED WATER SHALL BE TREATED TO REMOVE SEDIMENT PRIOR TO DISCHARGE
- 12. RESTORE TO EXISTING GRADE AS TRENCH BACKFILLING PROGRESSING. MAINTAIN PROPER SITE DRAINAGE TO PROTECT WORK AREA, ADJACENT PROPERTIES, SWALES, AND OTHER WATERCOURSES.
- 13. BOX OUT AREAS FOR PERVIOUS ACCESS ROADS AND EQUIPMENT PADS. AS UTILITY REPLACEMENTS ARE COMPLETE, PREPARE THE ROADWAY SUBGRADE AS REQUIRED.
- 14. INSTALL CONCRETE WASHOUT AREA. NO WET OR FRESH CONCRETE, WASHINGS FROM CONCRETE TRUCKS, MIXERS, OR OTHER DEVICES, OR CONCRETE LEACHATE SHALL BE ALLOWED TO ESCAPE INTO ANY WETLANDS OR WATERS.
- 15. INSTALL PERMANENT SEEDING, FERTILIZER, AND MULCH.
- 16. COMPLETE GRADING IF REQUIRED, REAPPLY TOPSOIL, INSTALL PERMANENT SEEDING, FERTILIZER, AND MULCH.
- 17. COMPLETE PERVIOUS ACCESS ROAD INSTALLATION ONCE ALL AREAS SUBJECT TO RUNOFF ONTO THE PERVIOUS ACCESS ROAD HAVE ACHIEVED FINAL STABILIZATION.
- 18. CAPTURE, REMOVE, AND DISPOSE OF ACCUMULATED SILT OR SEDIMENT FROM SILT FENCE, CHECK DAMS, INLET PROTECTION, AND SEDIMENT BASINS.
- 19. CLEAN THE SITE OF ALL INCIDENTAL CONSTRUCTION MATERIALS THAT ARE NOT INCORPORATED INTO THE WORK, AND PROPERLY DISPOSE OFFSITE.
- 20. SEED, MULCH, AND FERTILIZE TO ESTABLISH VEGETATION AT DISTURBED AREAS NOT DESIGNATED FOR PAVEMENT OR OTHER SURFACES. WHERE SEED DOES NOT GERMINATE OR WHERE WASHOUT, EROSION, RUTTING, OR OTHER DAMAGE OCCURS, REPAIR DAMAGE, RE-SEED AND RE-FERTILIZE AS NECESSARY TO ACHIEVE 80% GERMINATION OVER 100% OF THE SITE.
- 21. REMOVE ALL TEMPORARY EROSION CONTROL PRACTICES UPON APPROVAL OF FINAL STABILIZATION BY THE QUALIFIED INSPECTOR.



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NEXT ERA ENERGY

700 UNIVERSE BLVD. JUNO BEACH, FL 33408



2020 NY GREENFIELD PV DESIGN - RILEY ROAD 1

1902 RILEY RD. CORTLANDVILLE, NY 13045

DESCRIPTION:		
2201200.08		
BER		
DG	DG	
REVIEW		
NOVEMBER 2020		
	2201200.08 BER DG REVIEW	

CONSTRUCTION NOTES

DRAWING NUMBER:

C00⁻

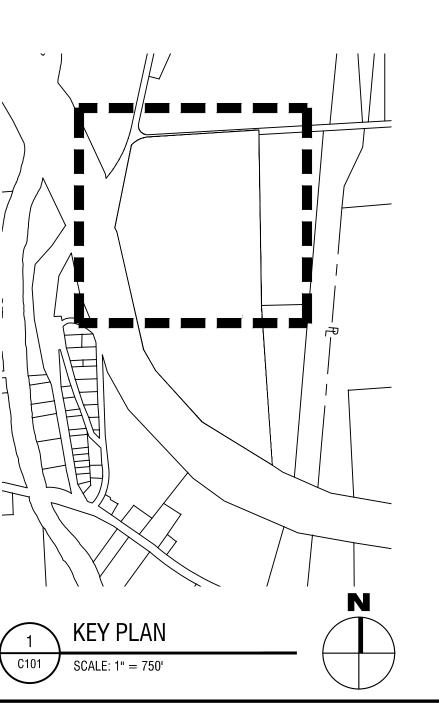


EXISTING CONDITIONS AND REMOVALS PLAN

DEMOLITION NOTES

- 1. EXISTING CONDITIONS ARE TAKEN FROM FIELD OBSERVATIONS AND PRIOR CONSTRUCTION DOCUMENTS WHEN AVAILABLE AND ARE NOT GUARANTEED. CONTRACTOR SHALL FIELD VERIFY ALL EXISTING CONDITIONS PRIOR TO BID. NO ALLOWANCE WILL BE MADE FOR ADDITIONAL COSTS DUE TO CONTRACTOR'S FAILURE TO VERIFY EXISTING CONDITIONS AND DIMENSIONS.
- 2. PRIOR TO THE START OF CONSTRUCTION, THE CONTRACTOR SHALL TO NOTIFY DIG SAFELY NEW YORK AT 811 TO REQUEST UTILITY STAKEOUT OF ALL PUBLIC UTILITIES.
- 3. THE HORIZONTAL AND VERTICAL LOCATION OF ALL EXISTING ABOVE GROUND AND BELOW GROUND UTILITIES, STRUCTURES, AND APPURTENANCES SHOWN ON THE PLANS ARE APPROXIMATE AND ARE NOT GUARANTEED. THE CONTRACTOR SHALL BE RESPONSIBLE FOR DETERMINING THE EXACT HORIZONTAL AND VERTICAL LOCATION OF ALL UTILITIES, STRUCTURES, AND APPURTENANCES IN THE PATH OF AND ADJACENT TO THE PROPOSED WORK.
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- 5. CONTRACTOR SHALL PROTECT AND SUPPORT ALL EXISTING UTILITIES DESIGNATED TO REMAIN FOR THE DURATION OF THE CONTRACT.
- 6. THE CONTRACTOR SHALL NOTIFY THE LOCAL GOVERNMENT, LOCAL FIRE DEPARTMENT AND THE NEW YORK STATE DEPARTMENT OF ENVIRONMENTAL CONSERVATION (NYSDEC) AS NECESSARY AND SHALL OBTAIN ANY REQUIRED PERMITS PRIOR TO BEGINNING WORK. COPIES OF ANY REQUIRED PERMITS SHALL BE PROVIDED TO THE OWNER PRIOR TO BEGINNING THE WORK.
- 7. CONTRACTOR SHALL REMOVE FROM SITE, MATERIALS NOT INDICATED TO BE SALVAGED INCLUDING ALL DEBRIS. ALL REMOVED MATERIALS SHALL BECOME THE PROPERTY OF CONTRACTOR WHO SHALL LEGALLY DISPOSE OF SAME.
- 8. ALL TREES, SHRUBS AND PLANTS DESIGNATED TO REMAIN AND DISTURBED BY CONSTRUCTION OPERATIONS, SHALL BE REPLACED IN-KIND AS DIRECTED BY THE ARCHITECT/ENGINEER AND/OR OWNER'S DESIGNATED REPRESENTATIVE AT NO ADDITIONAL COST TO THE OWNER.
- 9. THE CONTRACTOR SHALL MAINTAIN SAFE VEHICULAR AND PEDESTRIAN ACCESS TO THE EXISTING BUILDINGS FOR THE DURATION OF THE CONTRACT.
- 10. WHEN EXISTING CONSTRUCTION WHICH IS TO REMAIN IS DAMAGED DURING THE COURSE OF CONSTRUCTION AS A RESULT OF CONTRACTORS WORK, IT SHALL BE REPAIRED AND/OR REPLACED WITH SIMILAR OR LIKE MATERIALS AS MUCH AS POSSIBLE, AT NO COST TO THE OWNER. ALL REPAIRS AND/OR REPLACEMENTS WILL BE SUBJECT TO
- 11. COORDINATE LOCATION OF TEMPORARY CONSTRUCTION FENCE AND TEMPORARY STONE STAGING AREA WITH OWNER

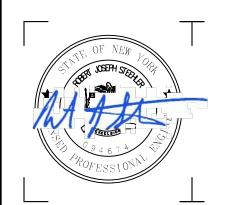
EXISTING	DESCRIPTION
alle.	WETLAND
	ROADWAY CENTERLINES
-x x	CHAIN LINK FENCE
	TREELINE
——	PROPERTY LINE
	SETBACK/BUFFER LINE
	EASEMENT LINE
	OVERHEAD ELECTRIC LINE
— — — — — — — — — — — — — — — — — — —	MAJOR CONTOUR
	€ OF DRAINAGE SWALE
-0-	UTILITY POLE W/O LIGHT





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NEXT ERA ENERGY

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2020 NY GREENFIELD PV DESIGN - RILEY ROAD 1

1902 RILEY RD. CORTLANDVILLE, NY 13045

NO:	DATE:	DESCRIPTION:	
Revisions			
PROJECT	NUMBER:	2201200.08	
DRAWN BY:		JMA	
REVIEWED BY:			
		DG	
ISSUED FO	DR:	REVIEW	
DATE:		NOVEMBER 2020	
		INUVEIVIDEN ZUZU	

EXISTING CONDITIONS AND REMOVALS PLAN (SHEET 1 OF 2)

DRAWING NUMBER:

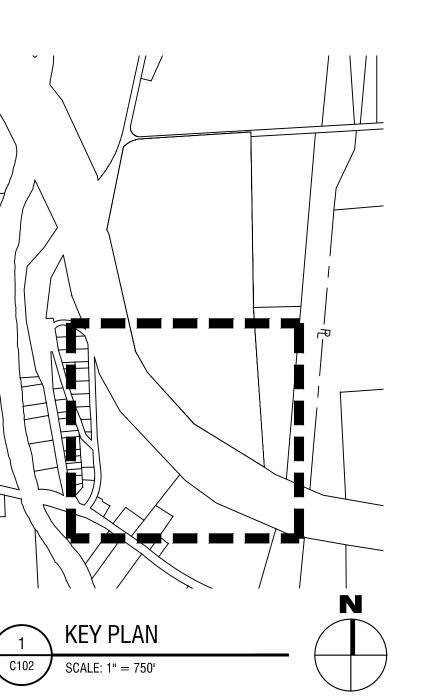


EXISTING CONDITIONS AND REMOVALS PLAN

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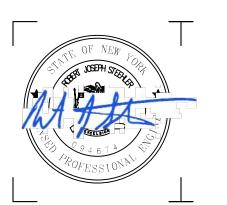
EXISTING	DESCRIPTION
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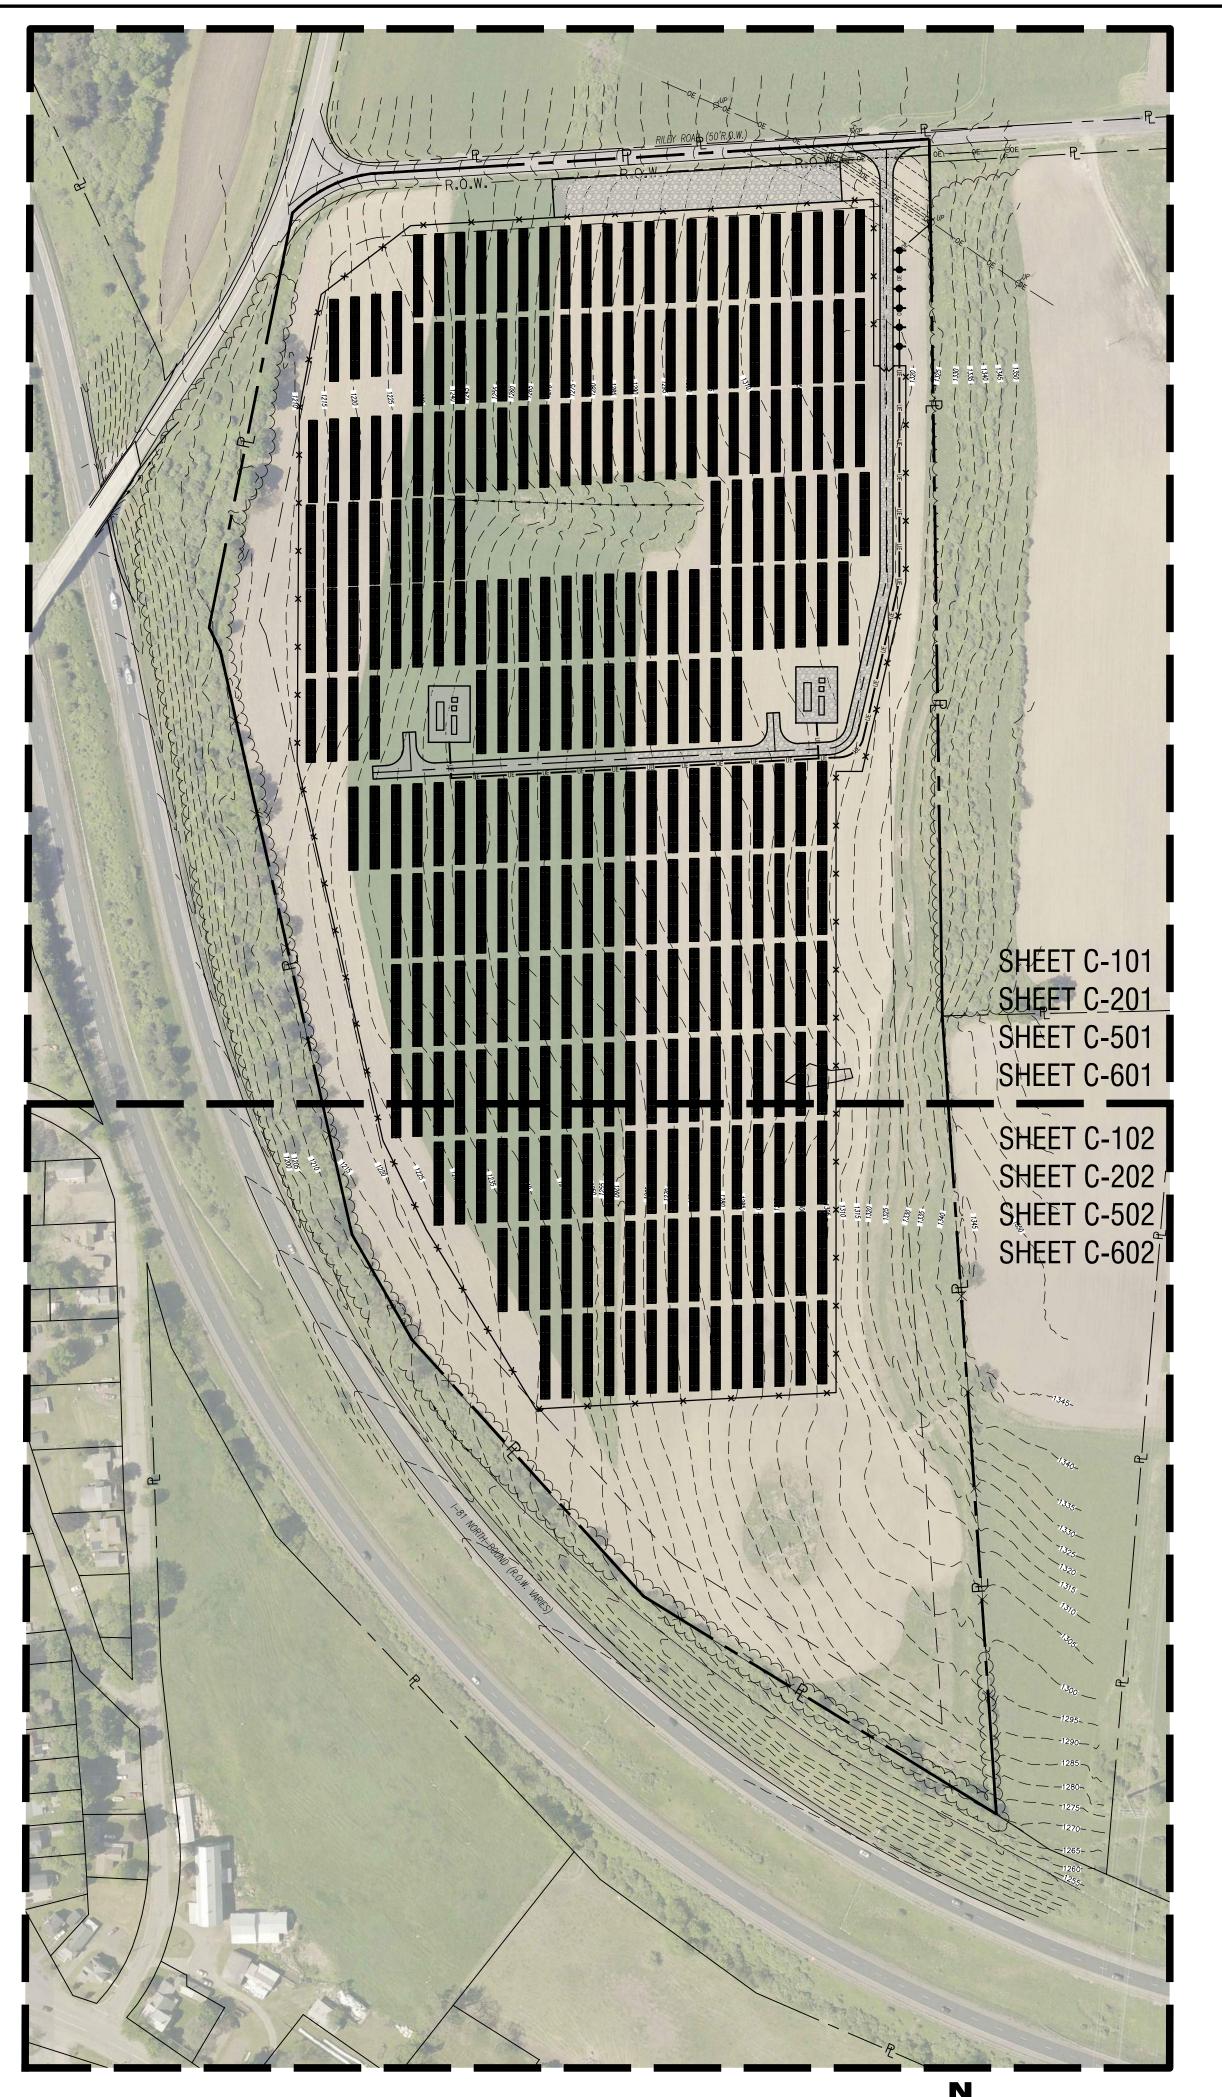
1902 RILEY RD. CORTLANDVILLE, NY 13045

NO:	DATE:	DESCRIPTION:	
Revisions			
PROJECT N	NUMBER:	2201200.08	
DRAWN BY:		JMA	
REVIEWED BY:		DG	
ISSUED FO	R:	REVIEW	
DATE:		NOVEMBER 2020	

EXISTING CONDITIONS AND REMOVALS PLAN (SHEET 2 OF 2)

DRAWING NUMBER:

DRAWING NAME:



SITE NOTES

- 1. WELL COMPACTED SUBGRADE SHALL BE UTILIZED UNDERNEATH CONSTRUCTION OF PAVEMENT AND CONCRETE BASES.
- 2. ALL STAKEOUT FOR THE PROPOSED SITE IMPROVEMENTS SHALL BE COMPLETED BY A NEW YORK STATE LICENSED LAND SURVEYOR.
- 3. IF ANY DISCREPANCIES ARE NOTED BETWEEN THESE CONSTRUCTION DOCUMENTS AND INFORMATION PROVIDED OR AN ERROR IS SUSPECT, IT SHALL BE IMMEDIATELY REPORTED TO THE CONSTRUCTION MANAGER AND LABELLA ASSOCIATES PROJECT MANAGER IN WRITING.
- 4. ANY PROOF-ROOLING OF EXPOSED SUBBASE BY A MINIMUM 10 TON SMOOTH DRUM ROLLER SHALL BE DONE UNDER THE GUIDANCE OF, AND OBSERVED BY, QUALIFIED ENGINEERING PERSONNEL PRIOR TO PLACEMENT OF SUBBASE MATERIAL. THE ROLLER SHOULD BE OPERATED IN THE STATIC MODE AND COMPLETE AT LEAST TWO (2) PASSES OVER THE EXPOSED SUBGRADES.

GENERAL UTILITY NOTES:

- 1. THE CONTRACTOR SHALL CONTACT DIG SAFE TO REQUEST A STAKEOUT PRIOR TO SOIL DISTURBANCE TO IDENTIFY LOCATION OF ALL EXISTING UTILITIES.
- 2. THE CONTRACTOR SHALL PROTECT ALL EXISTING UTILITIES UNLESS OTHERWISE NOTED ON THE DRAWINGS.

LEGEND

EXISTING	<u>PROPOSED</u>	DESCRIPTION
		WETLAND
		ROADWAY CENTERLINES
		PERVIOUS GRAVEL PAVEMENT
-x x	- ×	CHAIN LINK FENCE
<i></i>		TREELINE
— - — R — - —		PROPERTY LINE
		SETBACK LINE
		EASEMENT LINE
0E	—— OE ——— OE ———	OVERHEAD ELECTRIC LINE
	——— UE ———— UE ————	UNDERGROUND ELECTRIC LINE
-0-	•	UTILITY POLE W/O LIGHT



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NEXT ERA ENERGY

700 UNIVERSE BLVD. JUNO BEACH, FL 33408



2020 NY GREENFIELD PV DESIGN - RILEY ROAD 1

1902 RILEY RD. CORTLANDVILLE, NY 13045

NO:	DATE:	DESCRIPTION:	
Revisions			
PROJECT NUN	MBER:	2201200.08	
DRAWN BY:		JMA	
REVIEWED BY:		DG	
ISSUED FOR:		REVIEW	
DATE:		NOVEMBER 2020	
DRAWING NAI	ME:		

OVERALL SITE PLAN

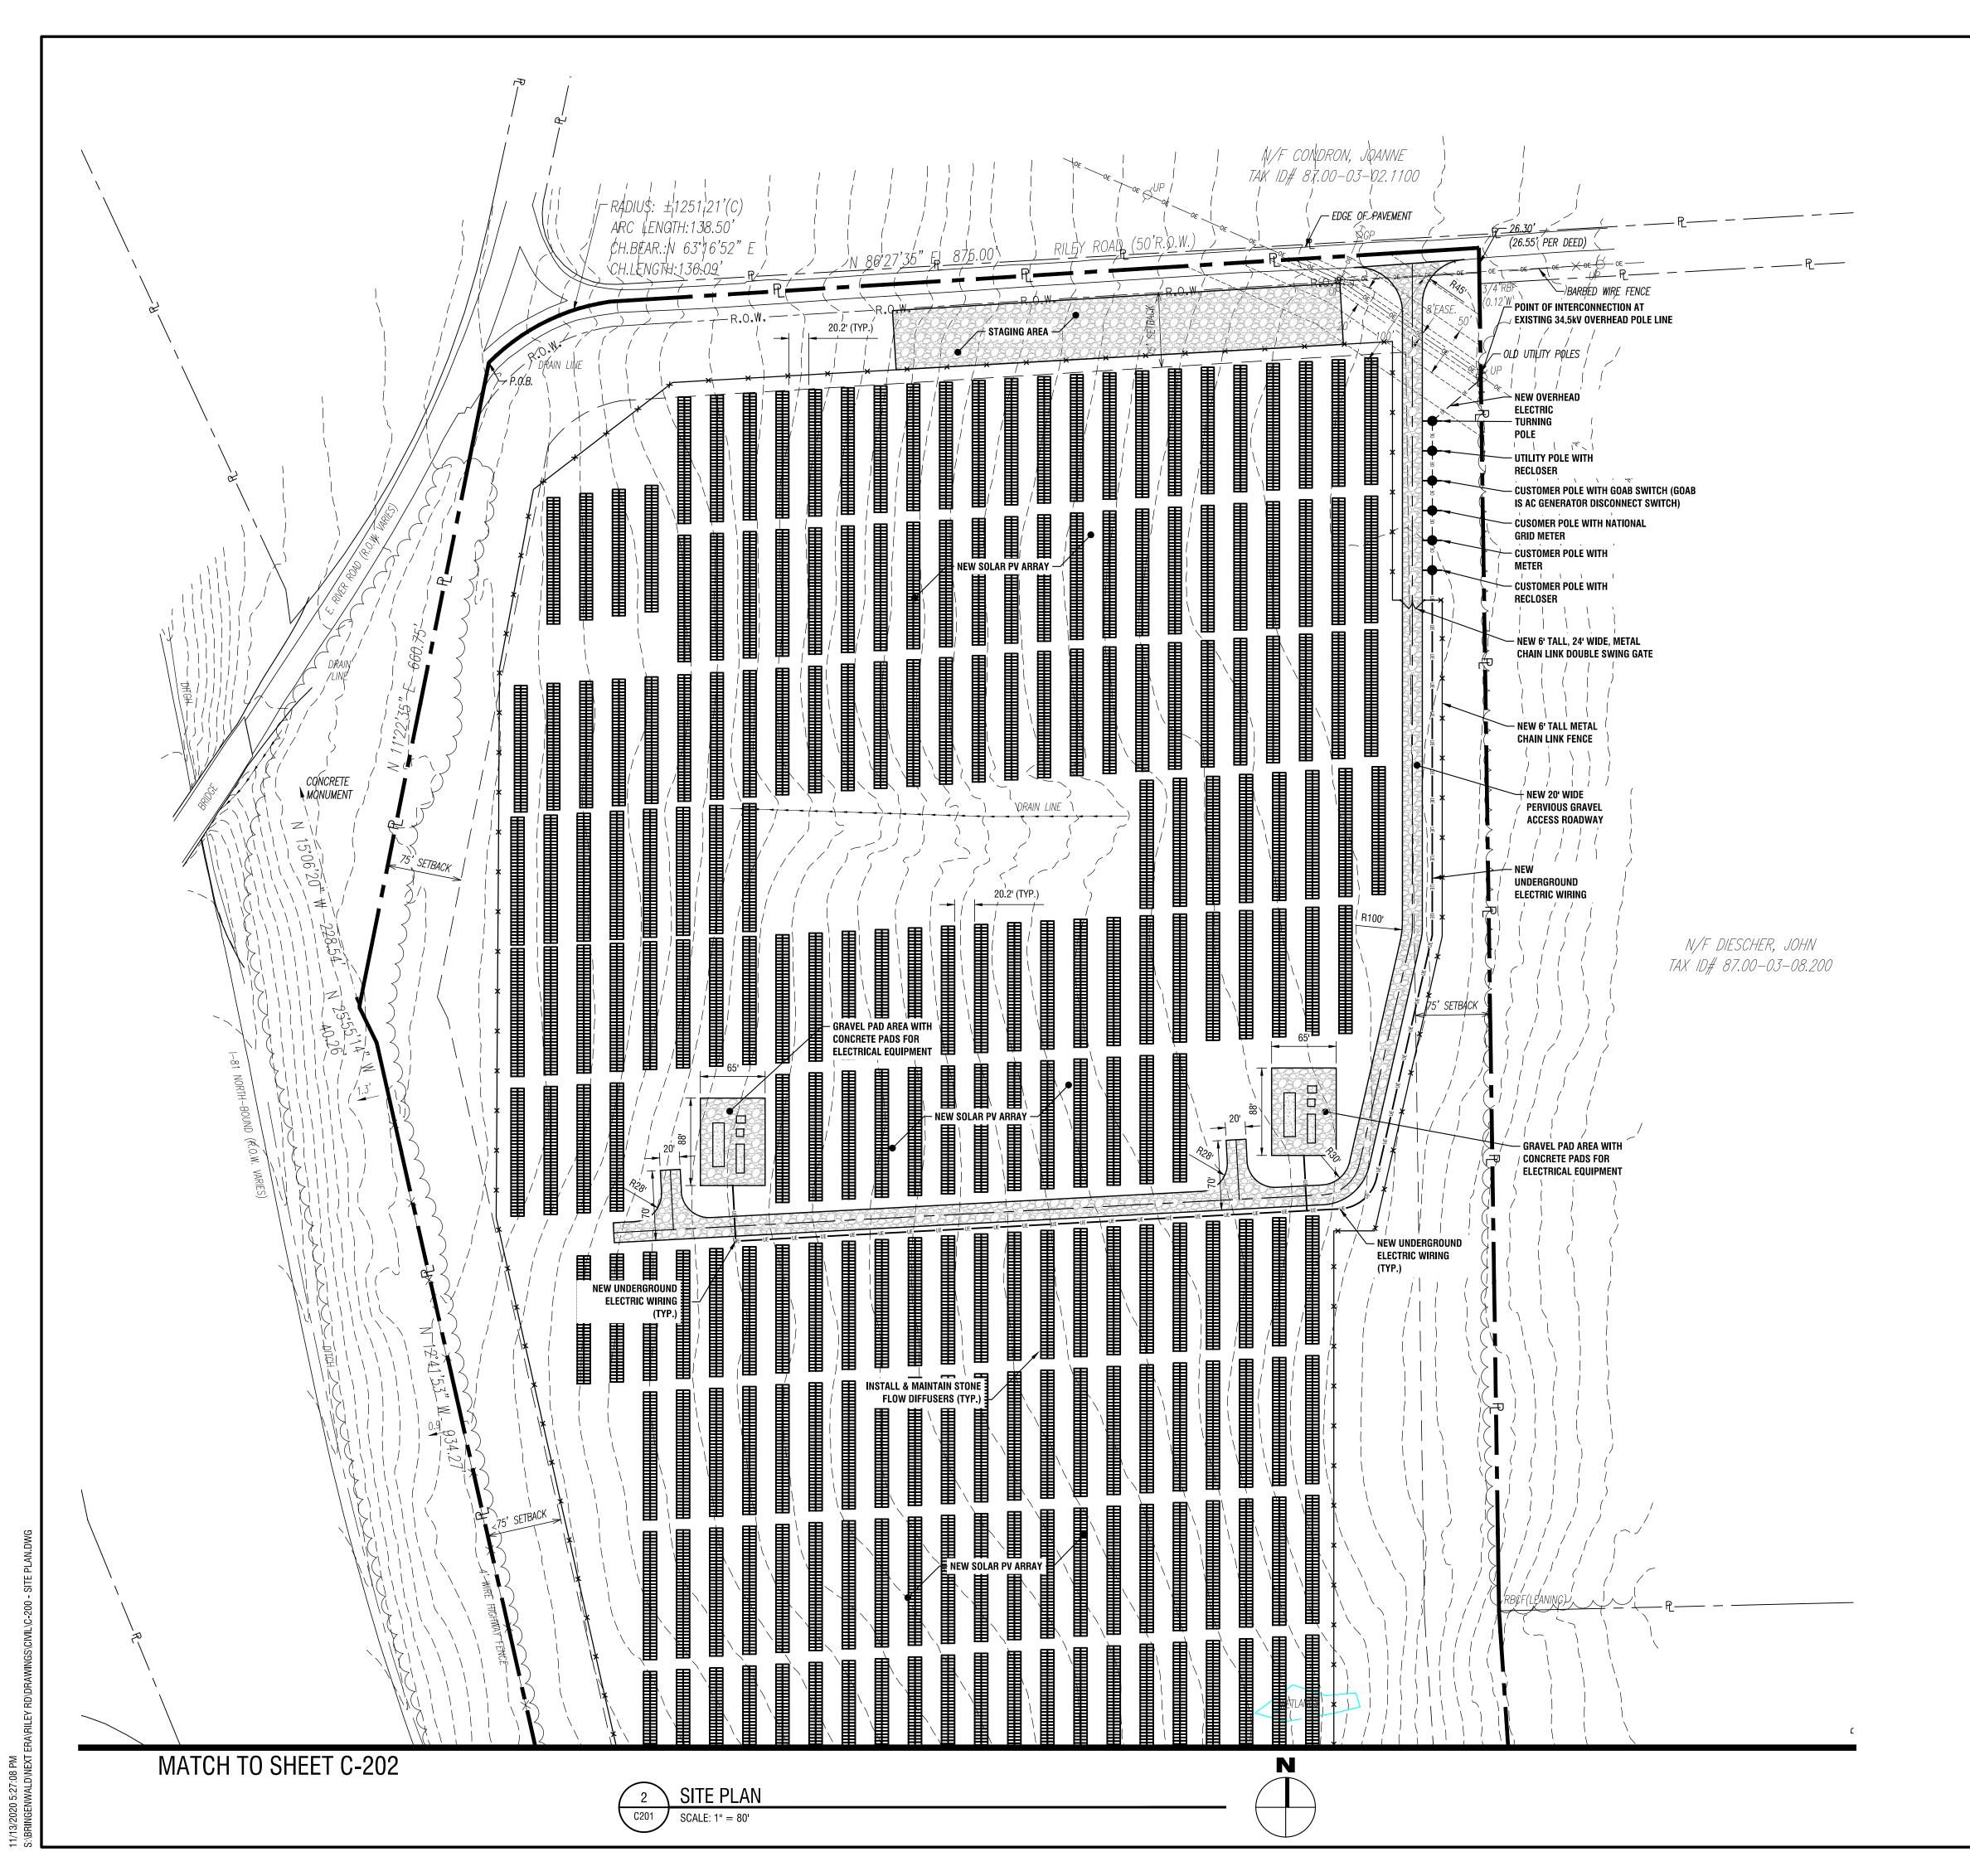
DRAWING NUMBER:

C200

1 OVERALL SITE PLAN

C200 SCALE: 1" = 150'





SITE NOTES

- 1. WELL COMPACTED SUBGRADE SHALL BE UTILIZED UNDERNEATH CONSTRUCTION OF PAVEMENT AND CONCRETE BASES.
- 2. ALL STAKEOUT FOR THE PROPOSED SITE IMPROVEMENTS SHALL BE COMPLETED BY A NEW YORK STATE LICENSED LAND SURVEYOR.
- 3. IF ANY DISCREPANCIES ARE NOTED BETWEEN THESE CONSTRUCTION DOCUMENTS AND INFORMATION PROVIDED OR AN ERROR IS SUSPECT, IT SHALL BE IMMEDIATELY REPORTED TO THE CONSTRUCTION MANAGER AND LABELLA ASSOCIATES PROJECT MANAGER IN WRITING.
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LEGEND

EXISTING	PROPOSED	DESCRIPTION
**		WETLAND
		ROADWAY CENTERLINES
		PERVIOUS GRAVEL PAVEMENT
_ _ ×	-× ×	CHAIN LINK FENCE
<i></i>		TREELINE
——		PROPERTY LINE
		SETBACK LINE
		EASEMENT LINE
0E	0E 0E	OVERHEAD ELECTRIC LINE
		UNDERGROUND ELECTRIC LINE
-0-	-	UTILITY POLE W/O LIGHT

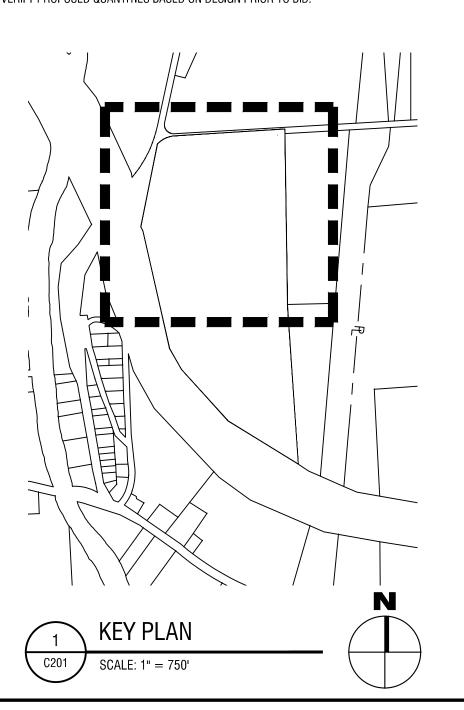
QUANTITIES TABLE

SITE AND UTILITY QUANTITIES

GRAVEL DRIVE	±37,085 SF
GRAVEL PAD	±9,700 SF
CONCRETE	±1,730 SF
6' TALL CHAIN LINK FENCING	±5,135 LF
12' CHAIN LINK DOUBLE SWING GATE	1
24' CHAIN LINK DOUBLE SWING GATE	1
UNDERGROUND ELECTRICAL WIRING	±1,390 LF
OVERHEAD ELECTRICAL WIRING	±215 LF
UTILITY POLES	6

NOTE:

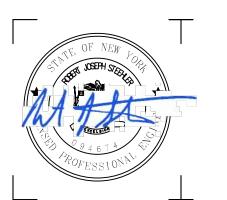
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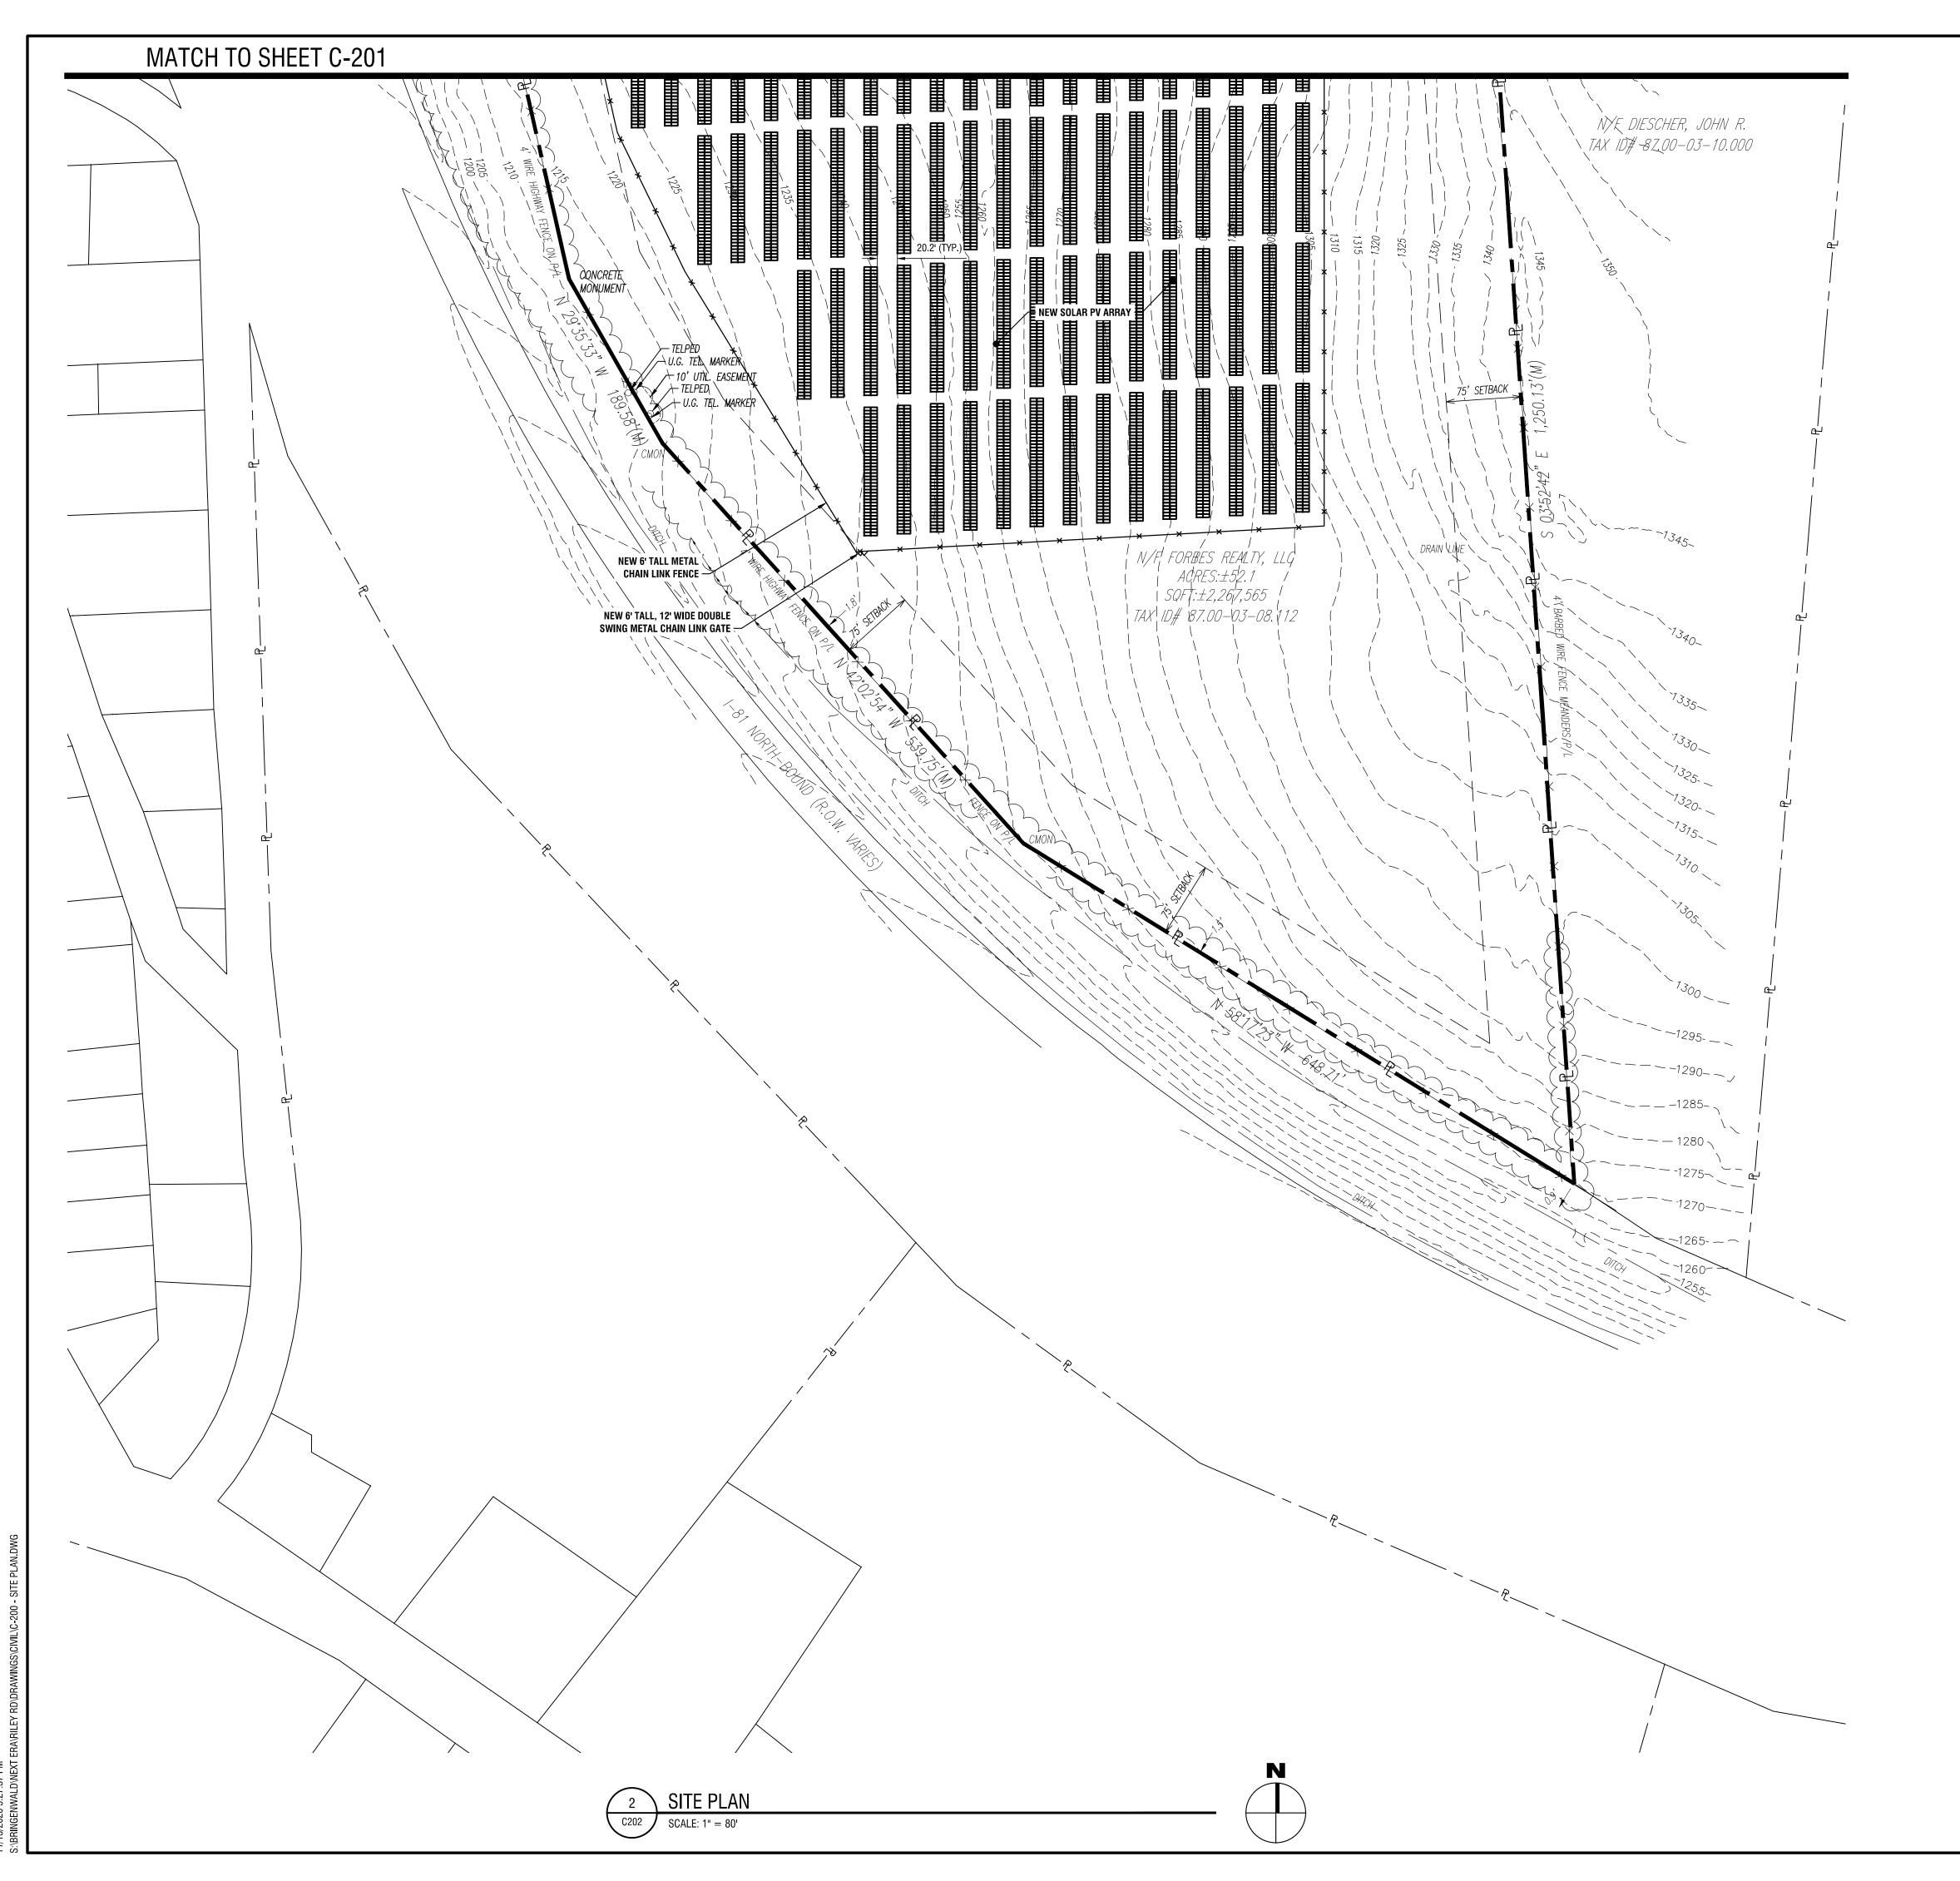
2020 NY GREENFIELD PV DESIGN - RILEY ROAD 1

1902 RILEY RD. CORTLANDVILLE, NY 13045

NO:	DATE:	DESCRIPTION:		
Revisions				
PROJECT N	IUMBER:	2201200.08		
DRAWN BY:		JMA		
REVIEWED BY:		DG		
ISSUED FO	R:	REVIEW		
DATE:		NOVEMBER 2020		
DRAWING I	NAME:			

SITE PLAN (SHEET 1 OF 2)

DRAWING NUMBER:



SITE NOTES

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LEGEND

EXISTING	PROPOSED	DESCRIPTION
<u> </u>		WETLAND
		ROADWAY CENTERLINES
		PERVIOUS GRAVEL PAVEMENT
_ X X	-× ×	CHAIN LINK FENCE
·····		TREELINE
—		PROPERTY LINE
		SETBACK LINE
		EASEMENT LINE
0E	—— OE ——— OE ———	OVERHEAD ELECTRIC LINE
	UEUE	UNDERGROUND ELECTRIC LINE
-0-	•	UTILITY POLE W/O LIGHT

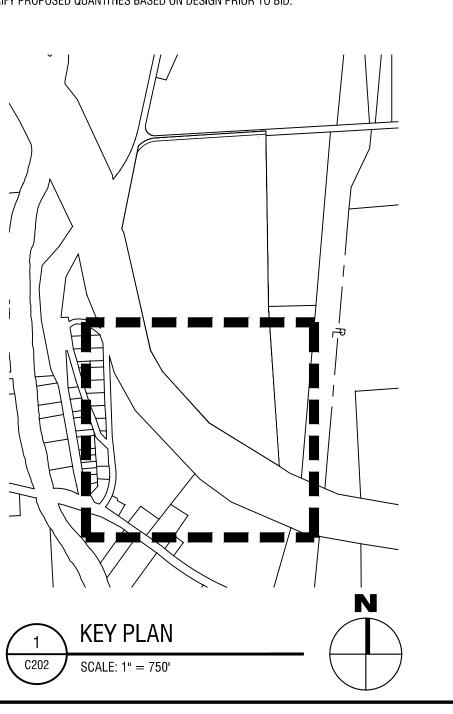
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UTILITY POLES	6

NOT

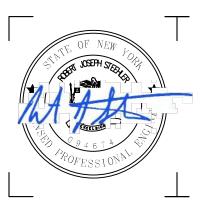
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2020 NY GREENFIELD PV DESIGN - RILEY ROAD 1

1902 RILEY RD.
CORTLANDVILLE, NY 13045

NO: DATE: DESCRIPTION:
Revisions

PROJECT NUMBER: 2201200.08

DRAWN BY: JMA
REVIEWED BY: DG

REVIEW

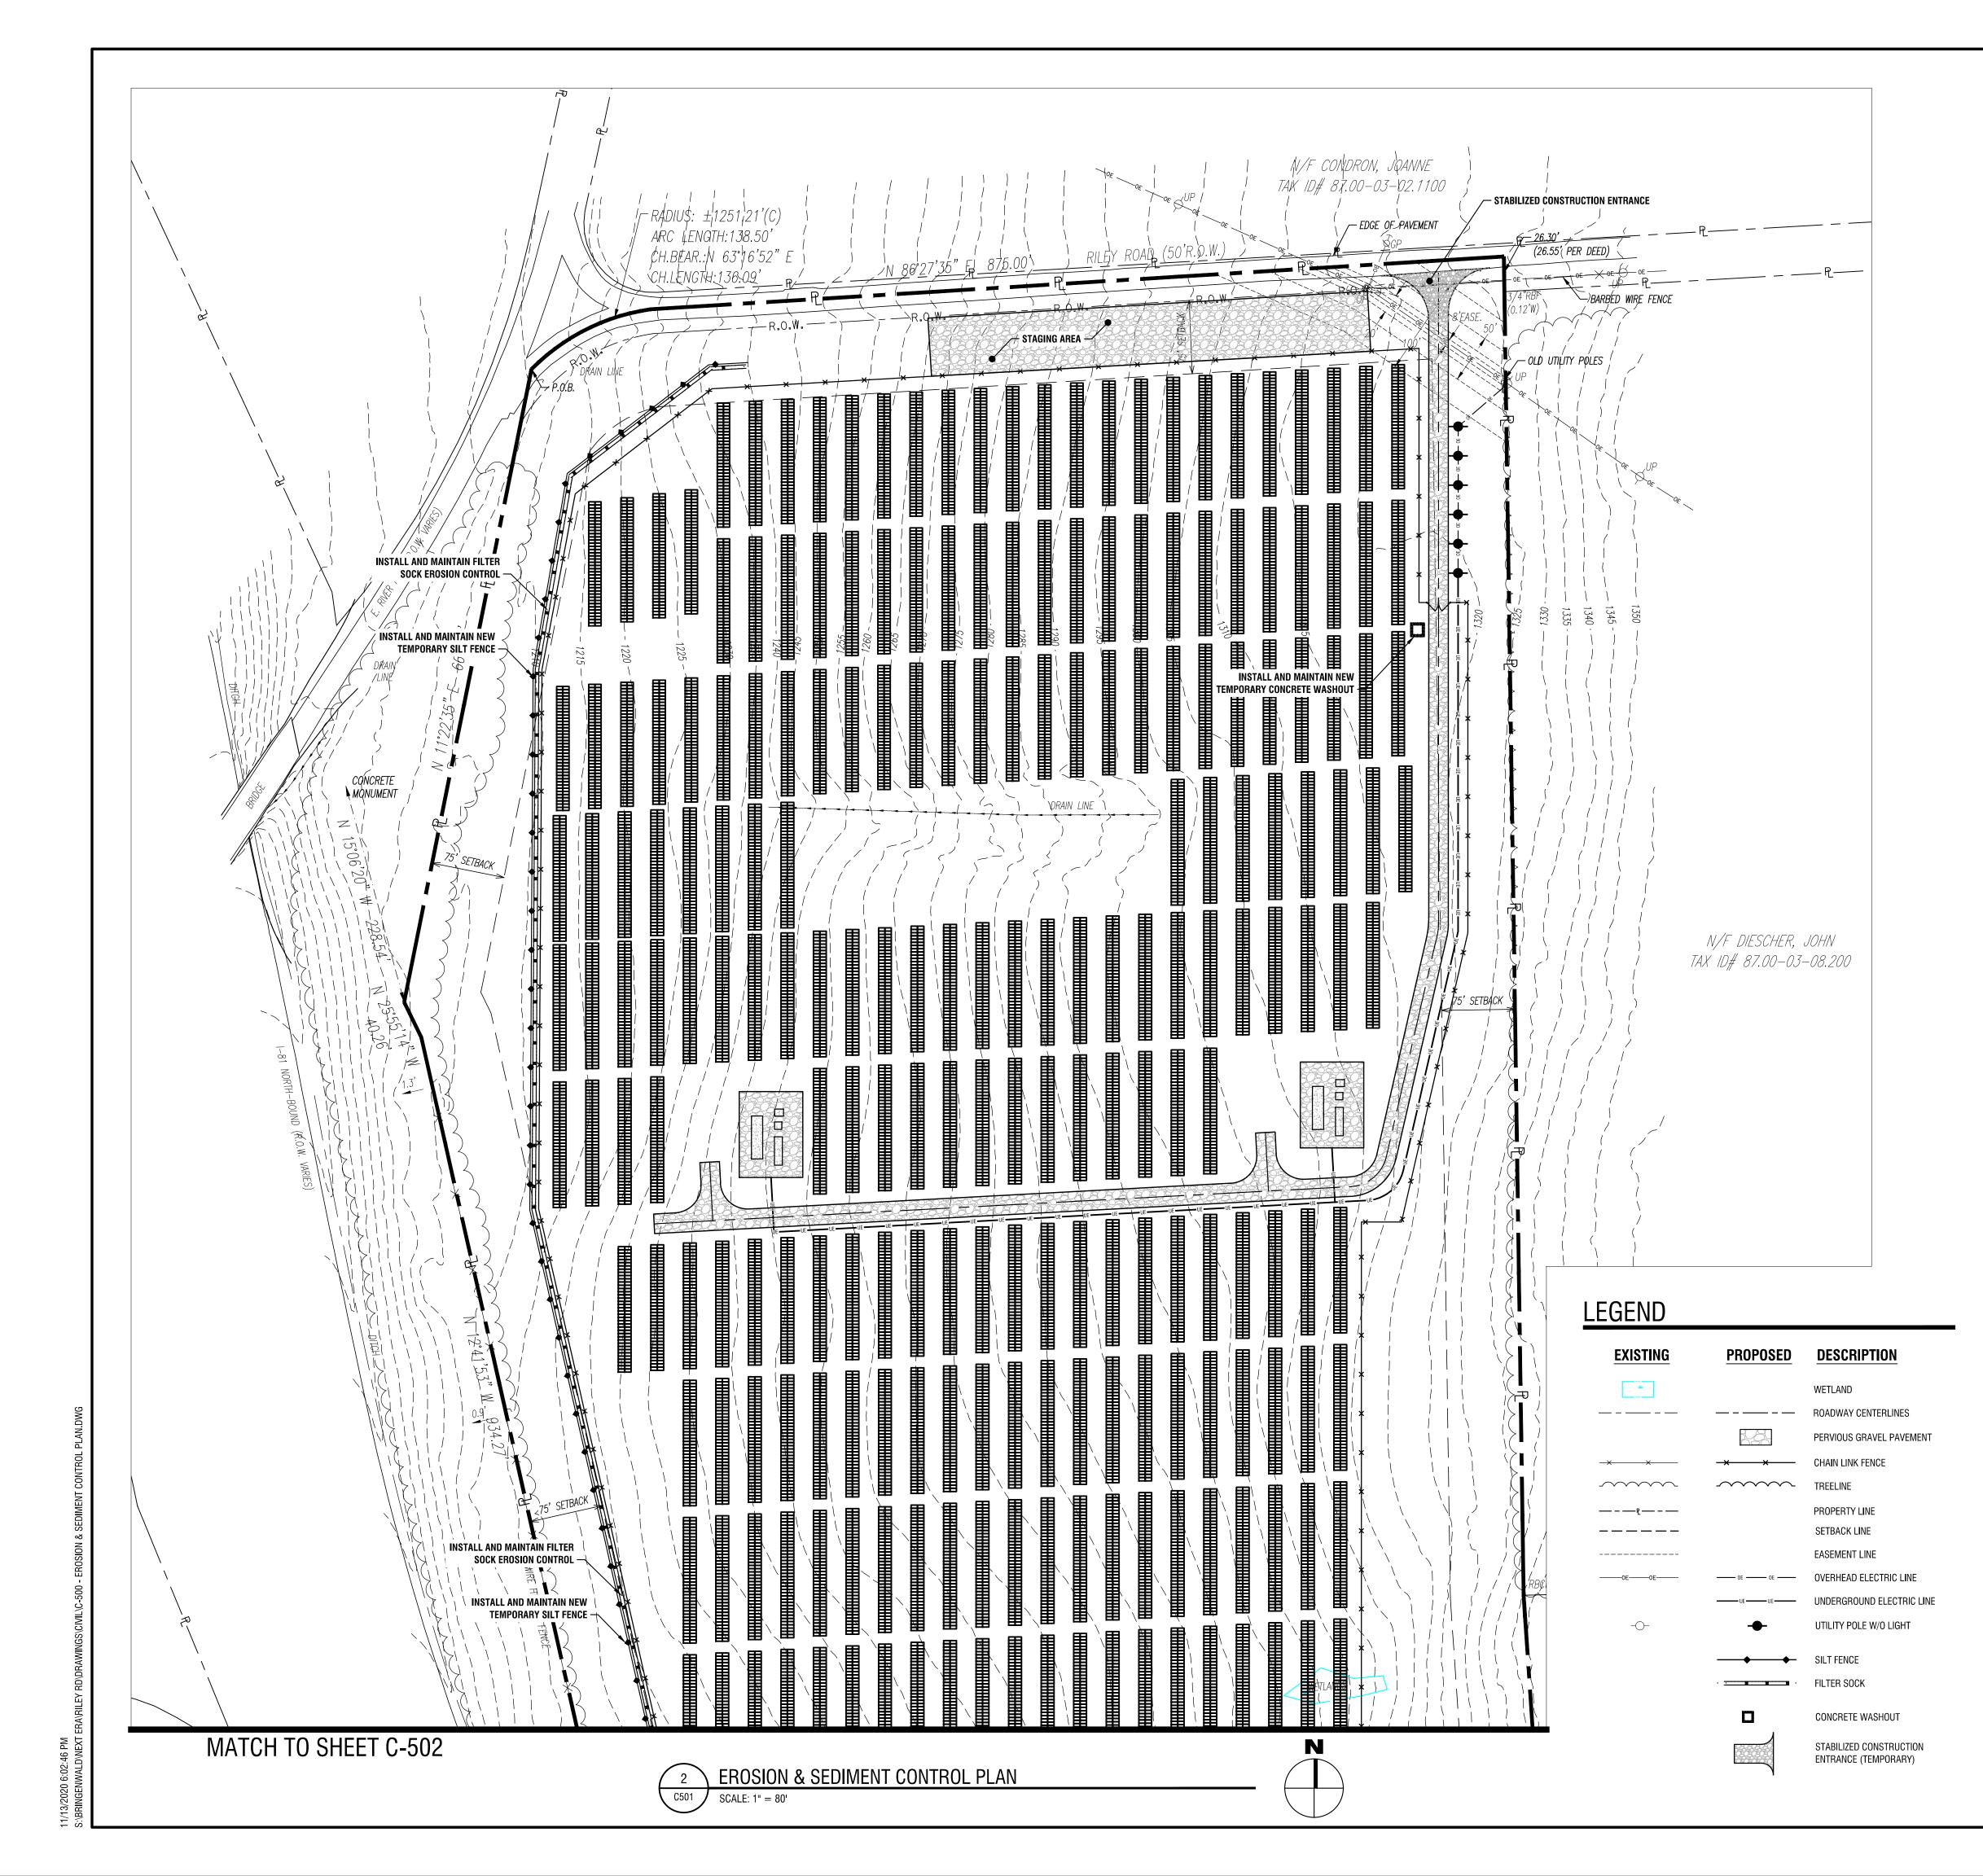
DATE: NOVEMBER 2020

DRAWING NAME:

ISSUED FOR:

SITE PLAN (SHEET 2 OF 2)

DRAWING NUMBER:



EROSION & SEDIMENT CONTROL NOTES

- 1. ALL EROSION CONTROL MEASURES SHALL BE IN ACCORDANCE WITH NEW YORK STANDARDS AND SPECIFICATIONS FOR EROSION AND SEDIMENT CONTROL, AND LOCAL GOVERNING SOIL AND WATER CONSERVATION AGENCY RECOMMENDATIONS AND STANDARDS. CONTRACTOR SHALL SUBMIT PROPOSED EROSION CONTROL PLAN INCLUDING SEQUENCING OF WORK TO THE ENGINEER FOR REVIEW PRIOR TO START OF WORK.
- 2. UTILIZE CONSTRUCTION METHODS/TECHNIQUES, WHICH WILL LIMIT THE EXPOSED EARTHEN AREAS AND MINIMIZE THE EFFECT OF EARTH DISTURBANCE ACTIVITIES ON SOIL EROSION.
- 3. RESTRICT DISTURBANCE TO UNDER 5 AC WITHOUT PRIOR WRITTEN APPROVAL FROM THE DEPARTMENT OF ENVIRONMENTAL CONSERVATION.
- 4. ALL SEDIMENTATION BARRIERS AND OTHER TEMPORARY OR PERMANENT MEASURES SHALL BE IN PLACE PRIOR TO THE START OF CONSTRUCTION. PLANS SHOW THE SUGGESTED MINIMUM MEASURES REQUIRED. EROSION AND SEDIMENT CONTROL MEASURES ARE TO BE ADJUSTED IN THE FIELD AS NEEDED DEPENDING ON CONSTRUCTION SEQUENCE. LOCATIONS TO BE VERIFIED BY STORMWATER INSPECTOR
- 5. REMOVAL OF ALL TEMPORARY EROSION AND SEDIMENTATION CONTROL MEASURES SHALL BE COMPLETED AT THE APPROVAL OF THE OWNER AND ENGINEER. THE COST OF REMOVING THESE MEASURES SHALL ALSO BE INCLUDED IN THE BID PRICE.
- 6. FOR THE DURATION OF THE PROJECT, THE CONTRACTOR SHALL PROTECT ALL ON-SITE, ADJACENT AND/OR DOWNSTREAM STORM/SANITARY SEWERS, AND/OR OTHER WATER COURSES FROM CONTAMINATION BY WATER BORNE SILTS, SEDIMENTS, FUELS, SOLVENTS, LUBRICANTS OR OTHER POLLUTANTS ORIGINATING FROM ANY WORK DONE ON, OR IN SUPPORT OF THIS PROJECT.
- 7. DURING CONSTRUCTION NO WET OR FRESH CONCRETE OR LEACHATE SHALL BE ALLOWED TO ESCAPE INTO STORM/SANITARY SEWERS, DITCHES OR OTHER WATERS OF NEW YORK STATE, NOR SHALL WASHINGS FROM CONCRETE TRUCKS, MIXERS OR OTHER DEVICES BE ALLOWED TO ENTER ANY STORM/SANITARY SEWERS, DITCHES, RIVERS, OR WATER COURSES.
- 8. ALL EXCAVATED OR IMPORTED EARTHEN STOCKPILES SHALL BE SUITABLY STABILIZED AND PROTECTED BY SILT FENCE SO THAT IT CANNOT REASONABLY ENTER ANY WATER BODY, OR STORM OR SANITARY SEWER.
- 9. ALL METHODS AND EQUIPMENT PROPOSED BY THE CONTRACTOR TO ACCOMPLISH THE WORK FOR EROSION AND POLLUTION CONTROL SHALL BE SUBJECT TO APPROVAL OF THE ENGINEER OR STORMAWATER INSPECTOR.
- 10. THE CONTRACTOR SHALL BE REQUIRED TO TREAT TRAVELED AREAS TO CONTROL DUST. WATER SHALL BE APPLIED TO SUCH TRAVELED AREAS AS THE ARCHITECT/ENGINEER OR OWNER'S DESIGNATED REPRESENTATIVE MAY DESIGNATE. THE NUMBER OF APPLICATIONS AND THE AMOUNT OF WATER SHALL BE BASED UPON FIELD AND WEATHER CONDITIONS.
- TO FURTHER EARTHWORK OR CONSTRUCTION ACTIVITIES SHALL BE PERMANENTLY SEEDED TO ESTABLISH GRASS, AND MULCHED WITH HAY OR STRAW WITHIN ONE WEEK OF FINAL DISTURBANCE. MULCH SHALL BE MAINTAINED UNTIL A SUITABLE VEGETATIVE COVER IS ESTABLISHED.
- 12. CONTRACTOR STAGING AREAS AND CONSTRUCTION ENTRANCE LOCATIONS SHALL BE COORDINATED WITH THE OWNER PRIOR TO START OF CONSTRUCTION. STABILIZED CONSTRUCTION ENTRANCE(S), AS SHOWN ON THE PLANS SHALL BE PROVIDED. ALL DISTURBED AREAS SHALL BE RESTORED.
- 13. ALL CATCH BASINS/DRAINAGE INLETS SHALL HAVE EITHER STONED INLET PROTECTION AROUND THEM AND GEOTEXTILE FABRIC OVER THE GRATE OR SEDIMENT SOCKS TO PREVENT SEDIMENTATION FROM ENTERING THE STORM SYSTEM.

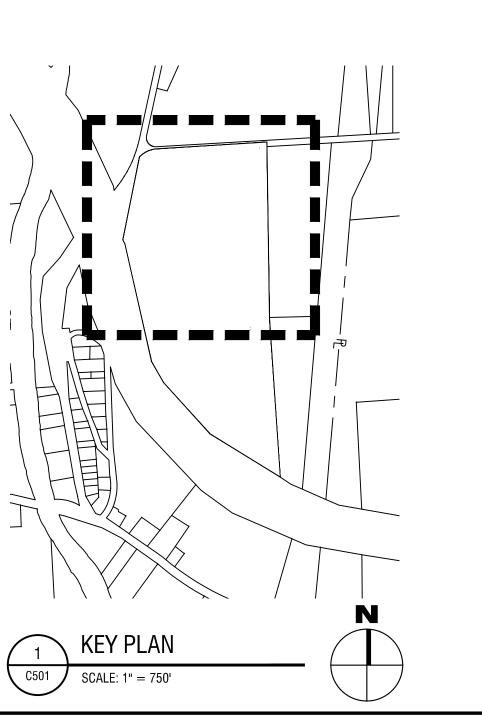
QUANTITIES TABLE

EROSION CONTROL QUANTITIES

STABILIZED ENTRANCE GRAVEL	±1,915 SF	
SILT FENCE	±2,090 LF	
FILTER SOCK	±2,0070 LF	
CONCRETE WASHOUT	1	
TOTAL DISTURBANCE AREA (AREA TO RECEIVE STRAW)	35.8 ACRES	

NOTE

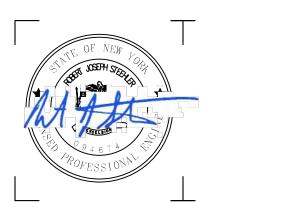
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2020 NY GREENFIELD PV DESIGN - RILEY ROAD 1

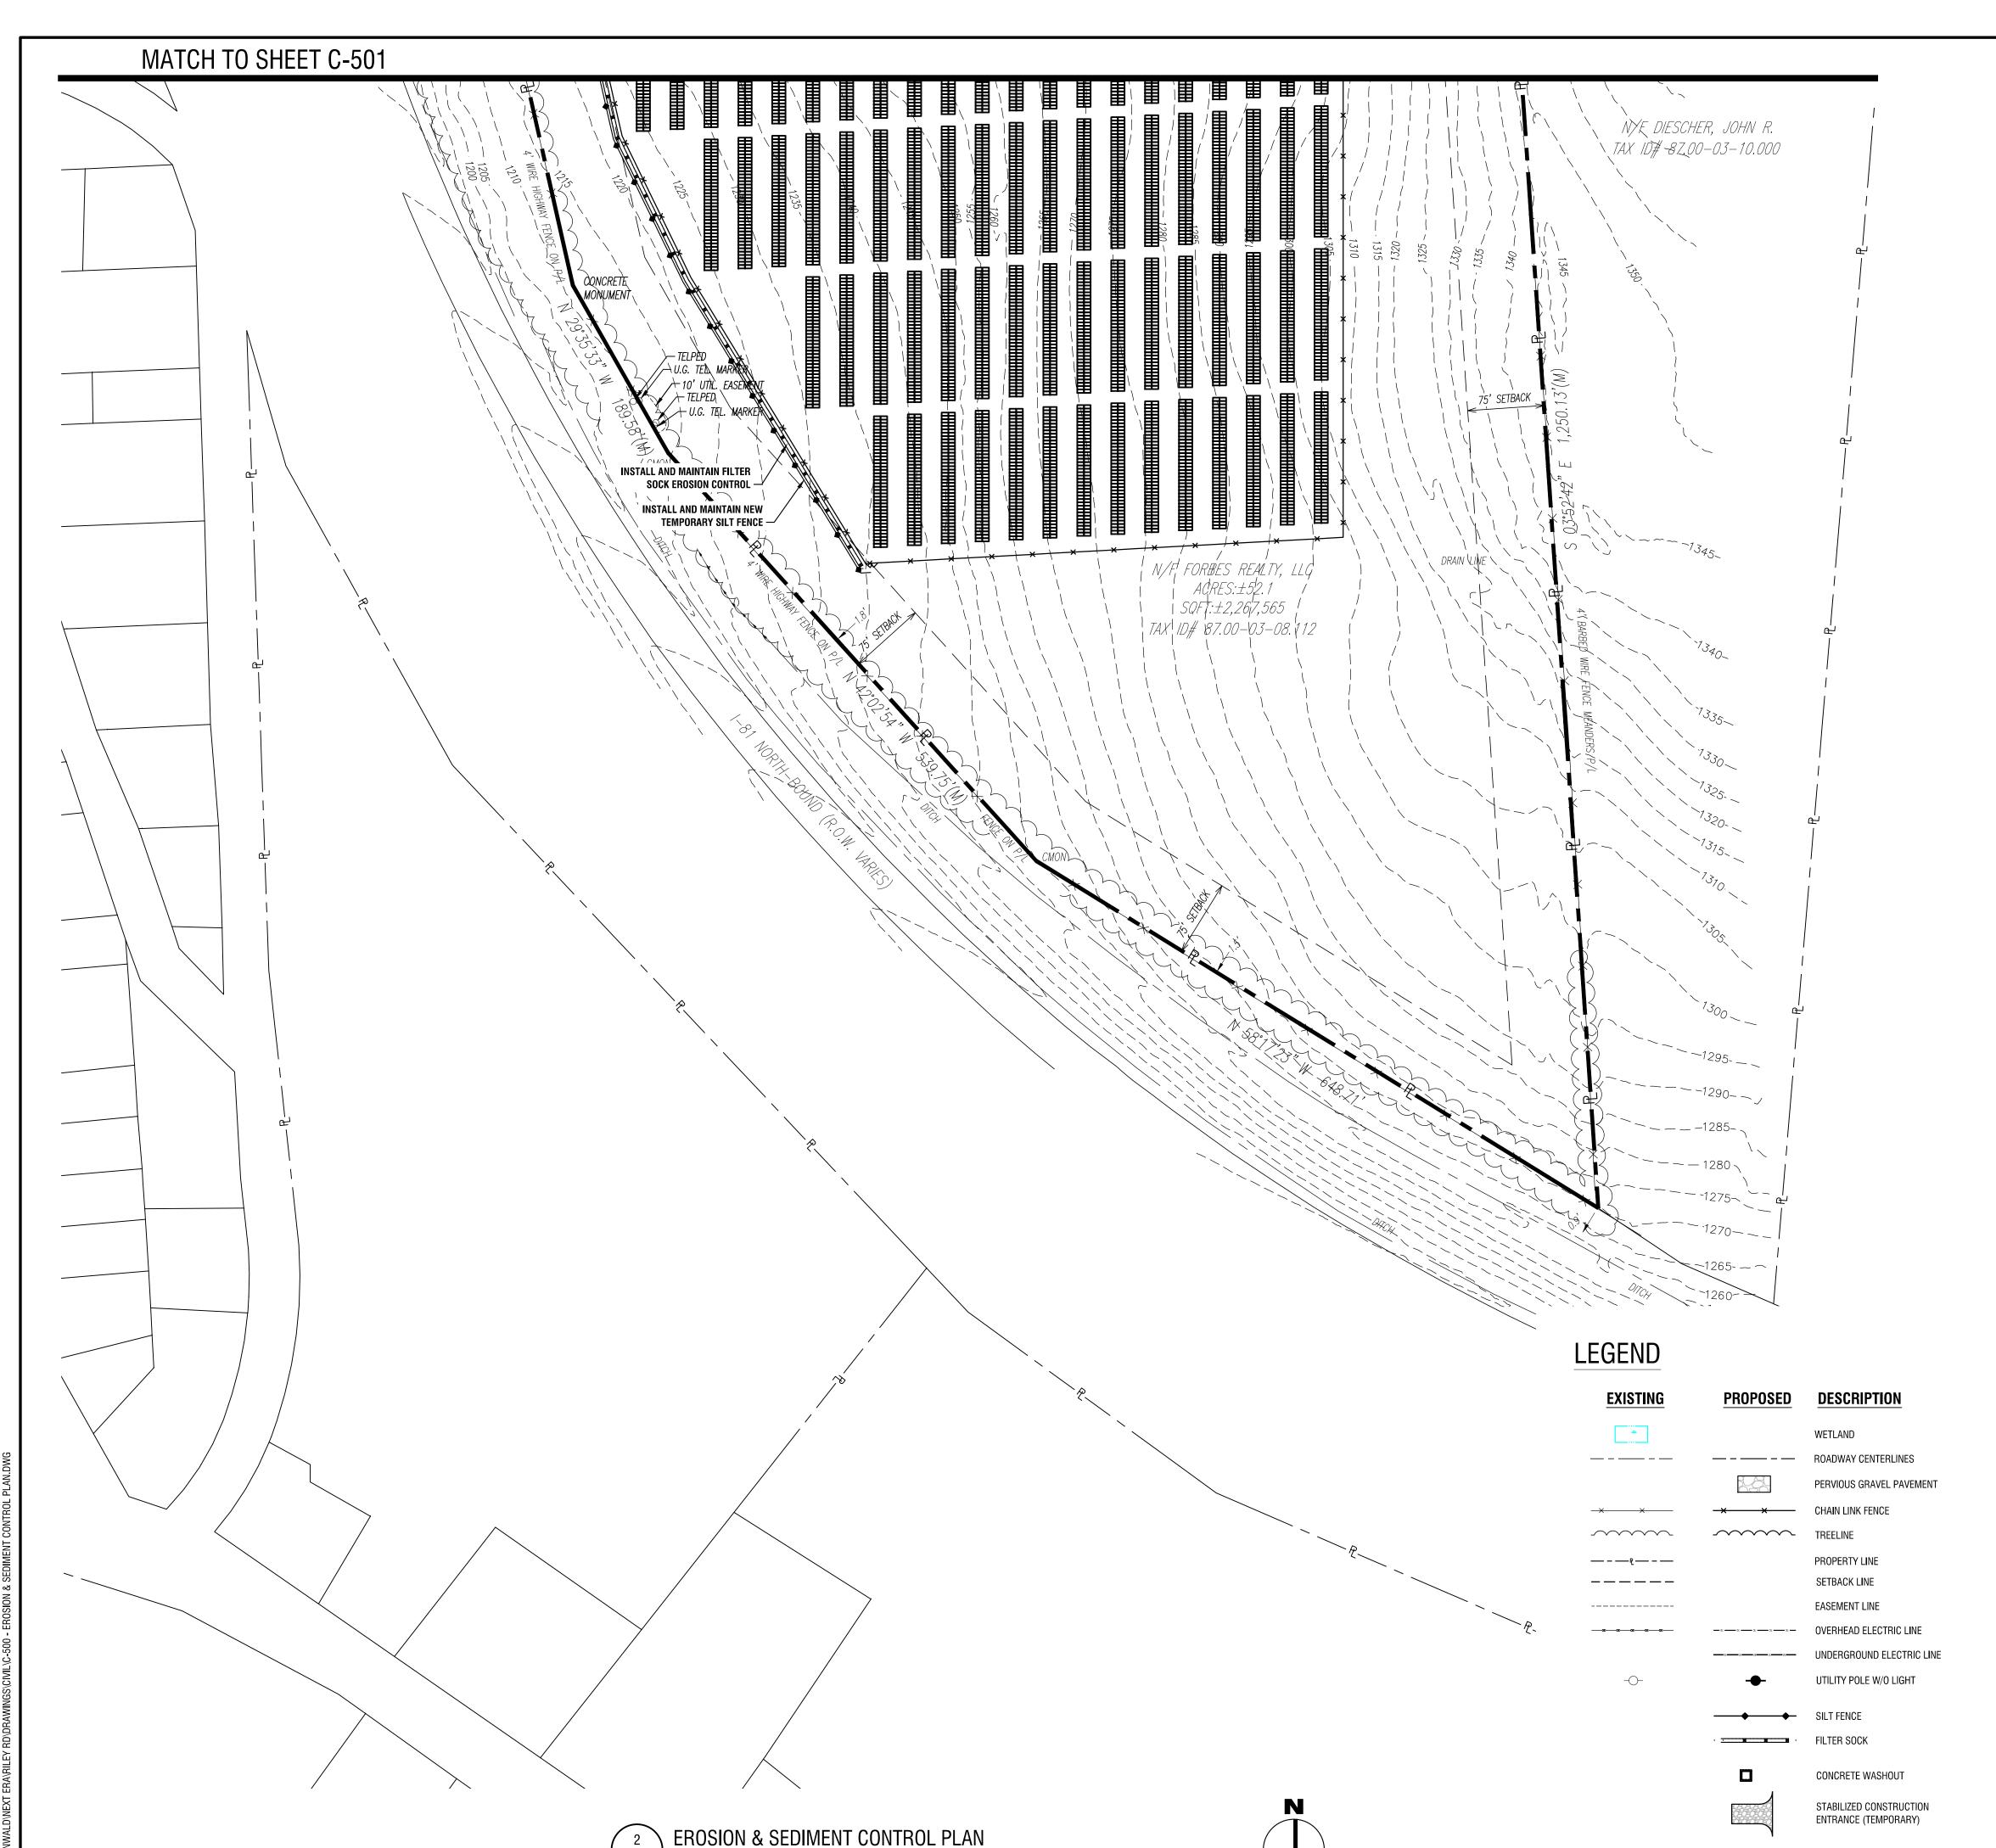
1902 RILEY RD. CORTLANDVILLE, NY 13045

NO:	DATE:	DESCRIPTION:	
Revisions			
PROJECT	NUMBER:	2201200.08	
DRAWN B	Y :	JMA	
REVIEWED BY:		DG	
ISSUED FO	OR:	REVIEW	
DATE:		NOVEMBER 2020	

EROSION & SEDIMENT CONTROL PLAN (SHEET 1 OF 2)

DRAWING NUMBER:

DRAWING NAME:



EROSION & SEDIMENT CONTROL NOTES

- 1. ALL EROSION CONTROL MEASURES SHALL BE IN ACCORDANCE WITH NEW YORK STANDARDS AND SPECIFICATIONS FOR EROSION AND SEDIMENT CONTROL, AND LOCAL GOVERNING SOIL AND WATER CONSERVATION AGENCY RECOMMENDATIONS AND STANDARDS. CONTRACTOR SHALL SUBMIT PROPOSED EROSION CONTROL PLAN INCLUDING SEQUENCING OF WORK TO THE ENGINEER FOR REVIEW PRIOR TO START OF WORK.
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- 11. ALL AREAS OF SOIL DISTURBANCE RESULTING FROM THIS PROJECT WHICH WILL NOT BE SUBJECT TO FURTHER EARTHWORK OR CONSTRUCTION ACTIVITIES SHALL BE PERMANENTLY SEEDED TO ESTABLISH GRASS, AND MULCHED WITH HAY OR STRAW WITHIN ONE WEEK OF FINAL DISTURBANCE. MULCH SHALL BE MAINTAINED UNTIL A SUITABLE VEGETATIVE COVER IS ESTABLISHED.
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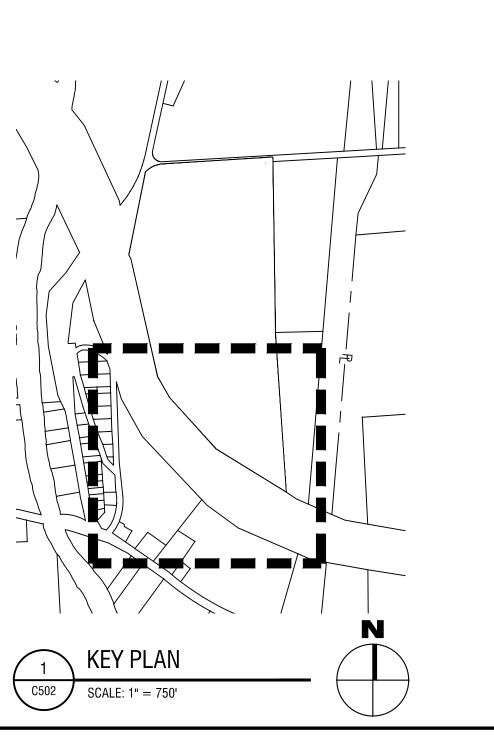
QUANTITIES TABLE

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CONCRETE WASHOUT	1
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NOTE

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NEXT ERA ENERGY

700 UNIVERSE BLVD. JUNO BEACH, FL 33408



2020 NY GREENFIELD PV DESIGN - RILEY ROAD 1

1902 RILEY RD. CORTLANDVILLE, NY 13045

DATE:	DESCRIPTION:			
PROJECT NUMBER: 2201200.08				

DRAWN BY:

REVIEWED BY:

DG

ISSUED FOR:

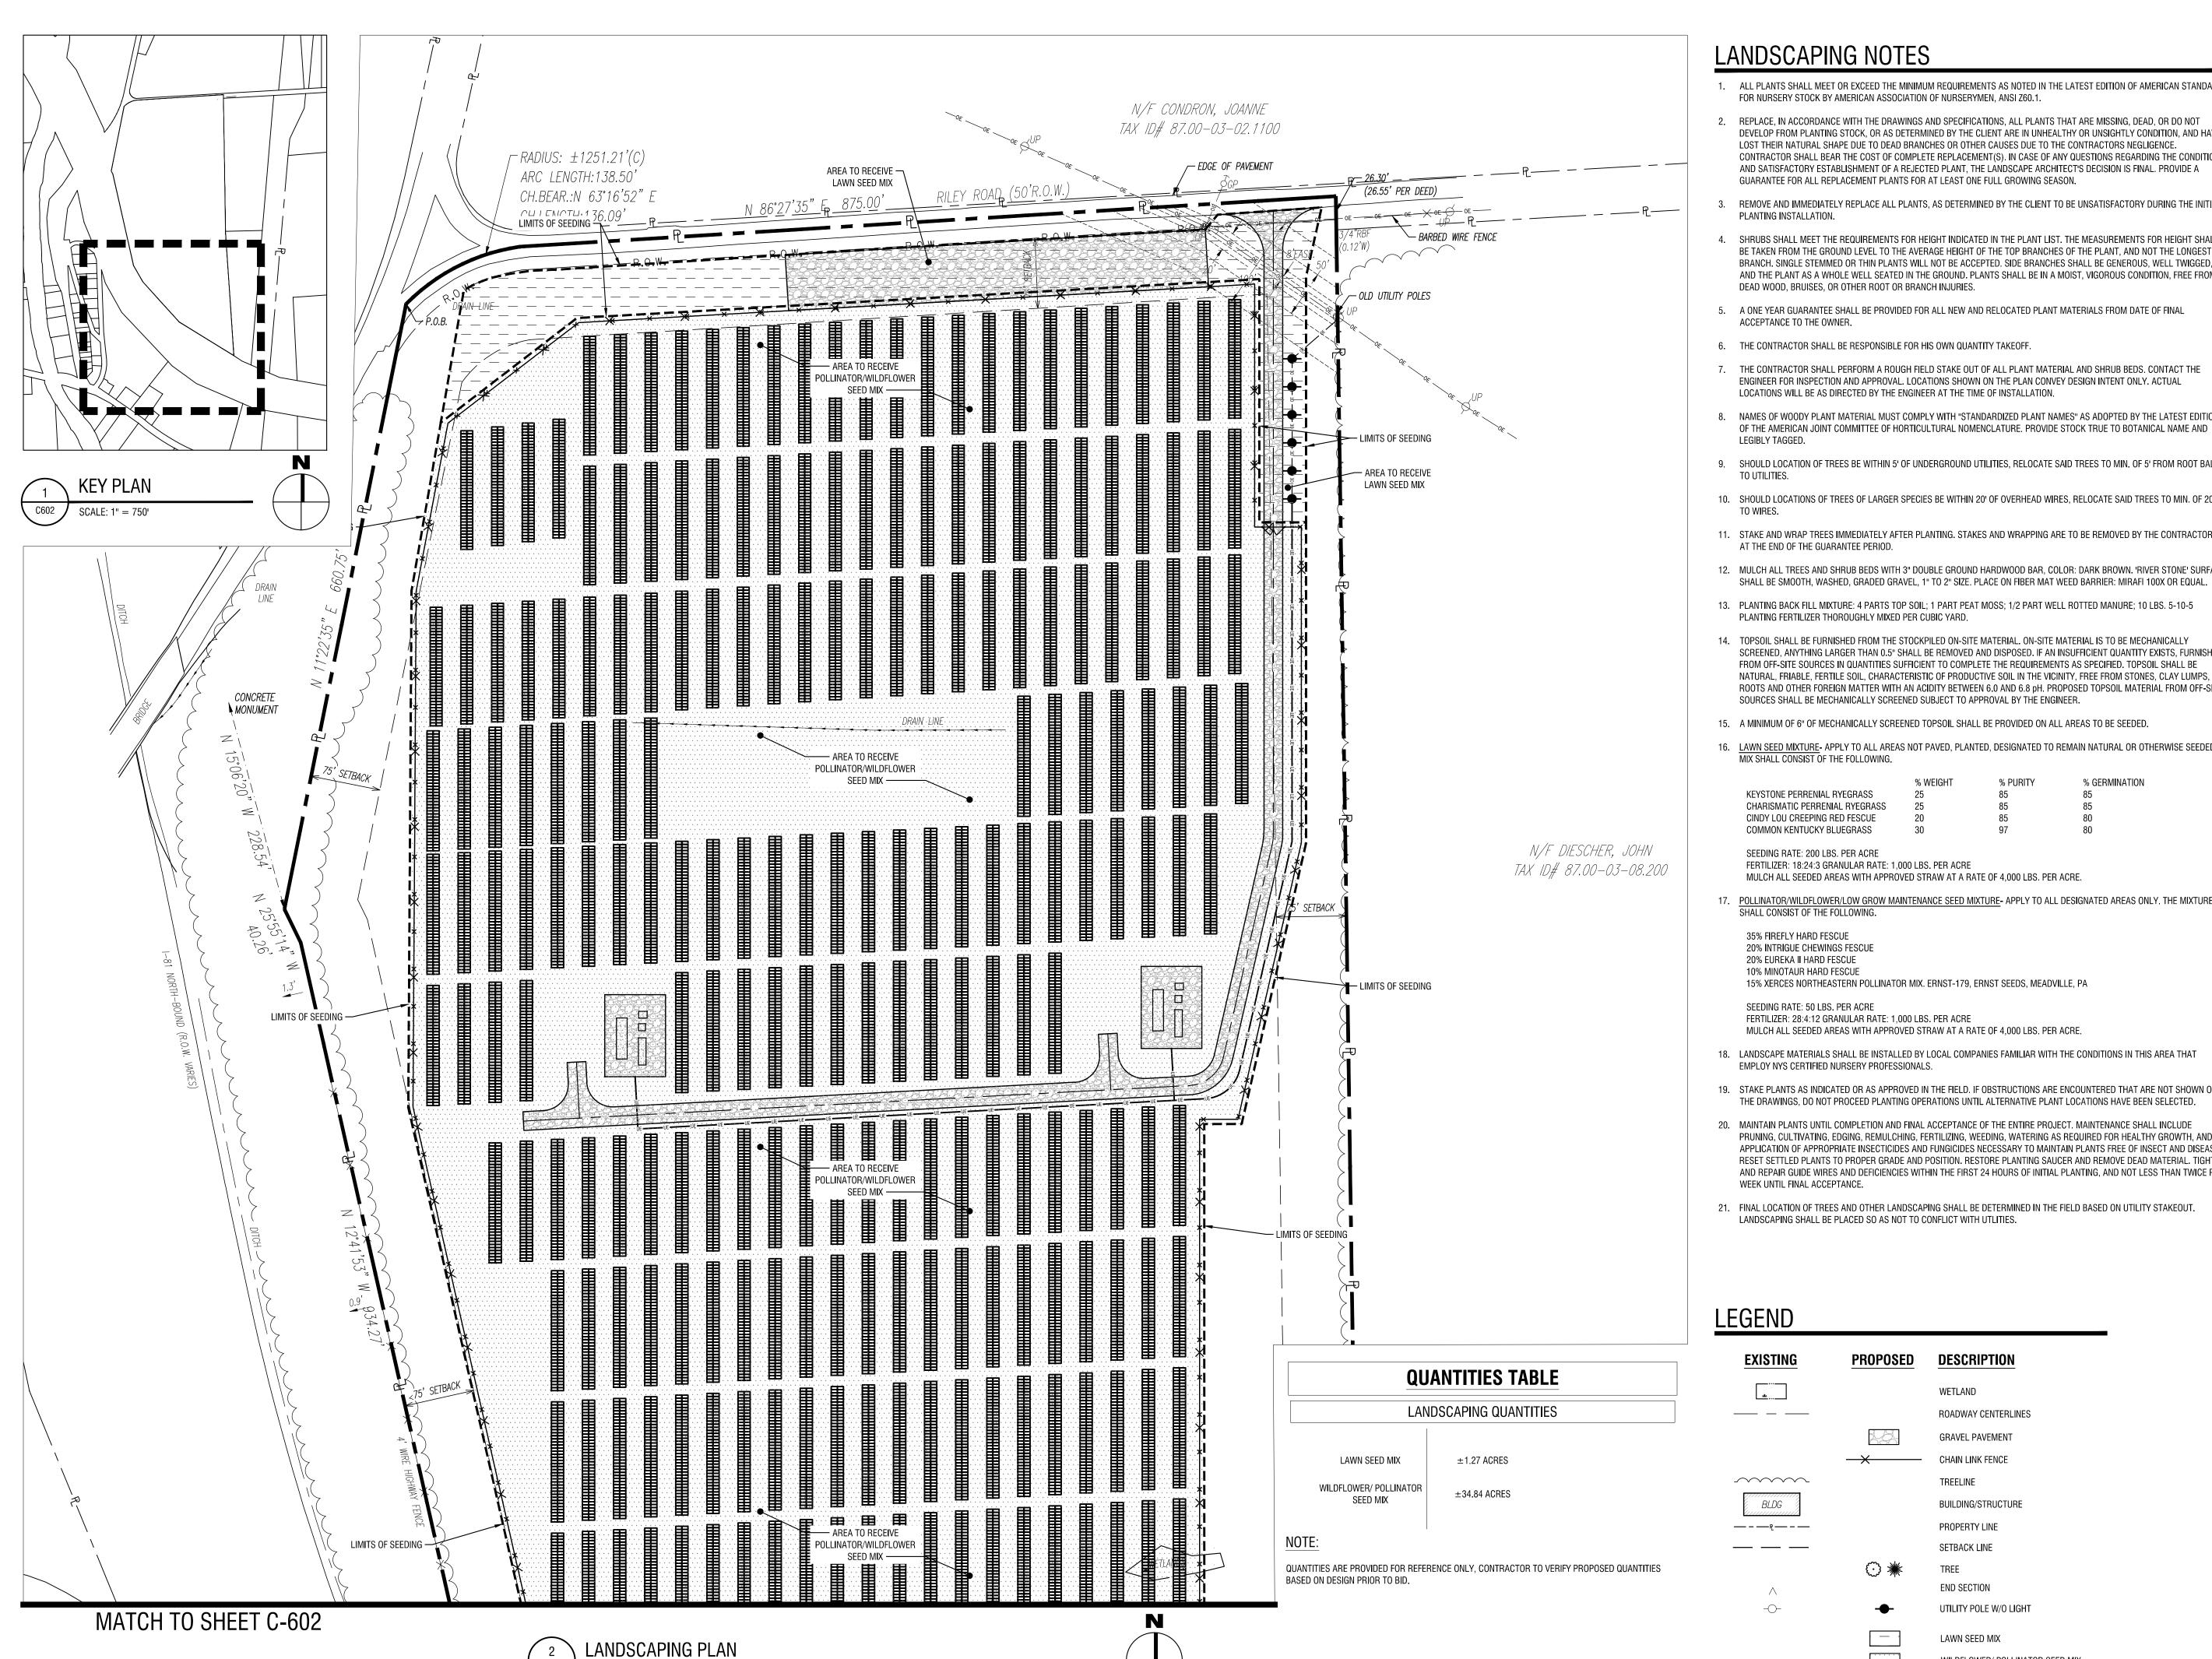
REVIEW

DATE: NOVEMBER 2020

DRAWING NAME:

EROSION & SEDIMENT CONTROL PLAN (SHEET 2 OF 2)

DRAWING NUMBER:



SCALE: 1" = 80'

LANDSCAPING NOTES

- 1. ALL PLANTS SHALL MEET OR EXCEED THE MINIMUM REQUIREMENTS AS NOTED IN THE LATEST EDITION OF AMERICAN STANDARD FOR NURSERY STOCK BY AMERICAN ASSOCIATION OF NURSERYMEN, ANSI Z60.1.
- REPLACE, IN ACCORDANCE WITH THE DRAWINGS AND SPECIFICATIONS, ALL PLANTS THAT ARE MISSING, DEAD, OR DO NOT DEVELOP FROM PLANTING STOCK, OR AS DETERMINED BY THE CLIENT ARE IN UNHEALTHY OR UNSIGHTLY CONDITION, AND HAVE CONTRACTOR SHALL BEAR THE COST OF COMPLETE REPLACEMENT(S). IN CASE OF ANY QUESTIONS REGARDING THE CONDITION AND SATISFACTORY ESTABLISHMENT OF A REJECTED PLANT, THE LANDSCAPE ARCHITECT'S DECISION IS FINAL. PROVIDE A GUARANTEE FOR ALL REPLACEMENT PLANTS FOR AT LEAST ONE FULL GROWING SEASON.
- REMOVE AND IMMEDIATELY REPLACE ALL PLANTS, AS DETERMINED BY THE CLIENT TO BE UNSATISFACTORY DURING THE INITIAL PLANTING INSTALLATION.
- SHRUBS SHALL MEET THE REQUIREMENTS FOR HEIGHT INDICATED IN THE PLANT LIST. THE MEASUREMENTS FOR HEIGHT SHALL BE TAKEN FROM THE GROUND LEVEL TO THE AVERAGE HEIGHT OF THE TOP BRANCHES OF THE PLANT, AND NOT THE LONGEST BRANCH. SINGLE STEMMED OR THIN PLANTS WILL NOT BE ACCEPTED. SIDE BRANCHES SHALL BE GENEROUS, WELL TWIGGED, AND THE PLANT AS A WHOLE WELL SEATED IN THE GROUND. PLANTS SHALL BE IN A MOIST, VIGOROUS CONDITION, FREE FROM DEAD WOOD, BRUISES, OR OTHER ROOT OR BRANCH INJURIES.
- 5. A ONE YEAR GUARANTEE SHALL BE PROVIDED FOR ALL NEW AND RELOCATED PLANT MATERIALS FROM DATE OF FINAL ACCEPTANCE TO THE OWNER.
- 6. THE CONTRACTOR SHALL BE RESPONSIBLE FOR HIS OWN QUANTITY TAKEOFF.
- 7. THE CONTRACTOR SHALL PERFORM A ROUGH FIELD STAKE OUT OF ALL PLANT MATERIAL AND SHRUB BEDS. CONTACT THE ENGINEER FOR INSPECTION AND APPROVAL. LOCATIONS SHOWN ON THE PLAN CONVEY DESIGN INTENT ONLY. ACTUAL LOCATIONS WILL BE AS DIRECTED BY THE ENGINEER AT THE TIME OF INSTALLATION.
- NAMES OF WOODY PLANT MATERIAL MUST COMPLY WITH "STANDARDIZED PLANT NAMES" AS ADOPTED BY THE LATEST EDITION OF THE AMERICAN JOINT COMMITTEE OF HORTICULTURAL NOMENCLATURE. PROVIDE STOCK TRUE TO BOTANICAL NAME AND
- 9. SHOULD LOCATION OF TREES BE WITHIN 5' OF UNDERGROUND UTILITIES, RELOCATE SAID TREES TO MIN. OF 5' FROM ROOT BALL
- 10. SHOULD LOCATIONS OF TREES OF LARGER SPECIES BE WITHIN 20' OF OVERHEAD WIRES, RELOCATE SAID TREES TO MIN. OF 20'
- 11. STAKE AND WRAP TREES IMMEDIATELY AFTER PLANTING. STAKES AND WRAPPING ARE TO BE REMOVED BY THE CONTRACTOR AT THE END OF THE GUARANTEE PERIOD.
- 12. MULCH ALL TREES AND SHRUB BEDS WITH 3" DOUBLE GROUND HARDWOOD BAR, COLOR: DARK BROWN. 'RIVER STONE' SURFACE
- 13. PLANTING BACK FILL MIXTURE: 4 PARTS TOP SOIL; 1 PART PEAT MOSS; 1/2 PART WELL ROTTED MANURE; 10 LBS. 5-10-5
- 14. TOPSOIL SHALL BE FURNISHED FROM THE STOCKPILED ON-SITE MATERIAL. ON-SITE MATERIAL IS TO BE MECHANICALLY SCREENED, ANYTHING LARGER THAN 0.5" SHALL BE REMOVED AND DISPOSED. IF AN INSUFFICIENT QUANTITY EXISTS, FURNISH FROM OFF-SITE SOURCES IN QUANTITIES SUFFICIENT TO COMPLETE THE REQUIREMENTS AS SPECIFIED. TOPSOIL SHALL BE

NATURAL, FRIABLE, FERTILE SOIL, CHARACTERISTIC OF PRODUCTIVE SOIL IN THE VICINITY, FREE FROM STONES, CLAY LUMPS,

ROOTS AND OTHER FOREIGN MATTER WITH AN ACIDITY BETWEEN 6.0 AND 6.8 ph. PROPOSED TOPSOIL MATERIAL FROM OFF-SITE

15. A MINIMUM OF 6" OF MECHANICALLY SCREENED TOPSOIL SHALL BE PROVIDED ON ALL AREAS TO BE SEEDED.

SOURCES SHALL BE MECHANICALLY SCREENED SUBJECT TO APPROVAL BY THE ENGINEER.

16. LAWN SEED MIXTURE- APPLY TO ALL AREAS NOT PAVED, PLANTED, DESIGNATED TO REMAIN NATURAL OR OTHERWISE SEEDED. MIX SHALL CONSIST OF THE FOLLOWING.

	% WEIGHT	% PURITY	% GERMINA
KEYSTONE PERRENIAL RYEGRASS	25	85	85
CHARISMATIC PERRENIAL RYEGRASS	25	85	85
CINDY LOU CREEPING RED FESCUE	20	85	80
COMMON KENTUCKY BLUEGRASS	30	97	80

FERTILIZER: 18:24:3 GRANULAR RATE: 1,000 LBS. PER ACRE MULCH ALL SEEDED AREAS WITH APPROVED STRAW AT A RATE OF 4,000 LBS. PER ACRE.

17. POLLINATOR/WILDFLOWER/LOW GROW MAINTENANCE SEED MIXTURE- APPLY TO ALL DESIGNATED AREAS ONLY. THE MIXTURE SHALL CONSIST OF THE FOLLOWING.

35% FIREFLY HARD FESCUE 20% INTRIGUE CHEWINGS FESCUE 20% EUREKA II HARD FESCUE 10% MINOTAUR HARD FESCUE

SEEDING RATE: 200 LBS. PER ACRE

15% XERCES NORTHEASTERN POLLINATOR MIX. ERNST-179, ERNST SEEDS, MEADVILLE, PA

SEEDING RATE: 50 LBS. PER ACRE FERTILIZER: 28:4:12 GRANULAR RATE: 1,000 LBS. PER ACRE MULCH ALL SEEDED AREAS WITH APPROVED STRAW AT A RATE OF 4,000 LBS. PER ACRE.

- 18. LANDSCAPE MATERIALS SHALL BE INSTALLED BY LOCAL COMPANIES FAMILIAR WITH THE CONDITIONS IN THIS AREA THAT EMPLOY NYS CERTIFIED NURSERY PROFESSIONALS.
- 19. STAKE PLANTS AS INDICATED OR AS APPROVED IN THE FIELD. IF OBSTRUCTIONS ARE ENCOUNTERED THAT ARE NOT SHOWN ON THE DRAWINGS. DO NOT PROCEED PLANTING OPERATIONS UNTIL ALTERNATIVE PLANT LOCATIONS HAVE BEEN SELECTED.
- 20. MAINTAIN PLANTS UNTIL COMPLETION AND FINAL ACCEPTANCE OF THE ENTIRE PROJECT. MAINTENANCE SHALL INCLUDE PRUNING, CULTIVATING, EDGING, REMULCHING, FERTILIZING, WEEDING, WATERING AS REQUIRED FOR HEALTHY GROWTH, AND APPLICATION OF APPROPRIATE INSECTICIDES AND FUNGICIDES NECESSARY TO MAINTAIN PLANTS FREE OF INSECT AND DISEASE. RESET SETTLED PLANTS TO PROPER GRADE AND POSITION. RESTORE PLANTING SAUCER AND REMOVE DEAD MATERIAL. TIGHTEN AND REPAIR GUIDE WIRES AND DEFICIENCIES WITHIN THE FIRST 24 HOURS OF INITIAL PLANTING, AND NOT LESS THAN TWICE PER WEEK UNTIL FINAL ACCEPTANCE.
- 21. FINAL LOCATION OF TREES AND OTHER LANDSCAPING SHALL BE DETERMINED IN THE FIELD BASED ON UTILITY STAKEOUT. LANDSCAPING SHALL BE PLACED SO AS NOT TO CONFLICT WITH UTLITIES.

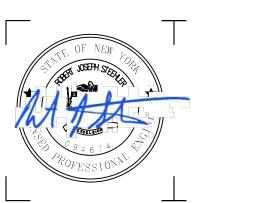
LEGEND

EXISTING	PROPOSED	DESCRIPTION
<u>sk</u>		WETLAND
		ROADWAY CENTERLINES
		GRAVEL PAVEMENT
	- X	CHAIN LINK FENCE
······		TREELINE
BLDG		BUILDING/STRUCTURE
— – — 원 — – —		PROPERTY LINE
		SETBACK LINE
	♡ *	TREE
\wedge		END SECTION
-0-	-	UTILITY POLE W/O LIGHT
		LAWN SEED MIX
		WILDFLOWER/ POLLINATOR SEED MIX



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NEXT ERA ENERGY

700 UNIVERSE BLVD. JUNO BEACH, FL 33408



2020 NY GREENFIELD PV DESIGN - RILEY ROAD 1

1902 RILEY RD. CORTLANDVILLE, NY 13045

NO: DATE: DESCRIPTION: Revisions

PROJECT NUMBER:

2201200.08 DRAWN BY:

REVIEWED BY:

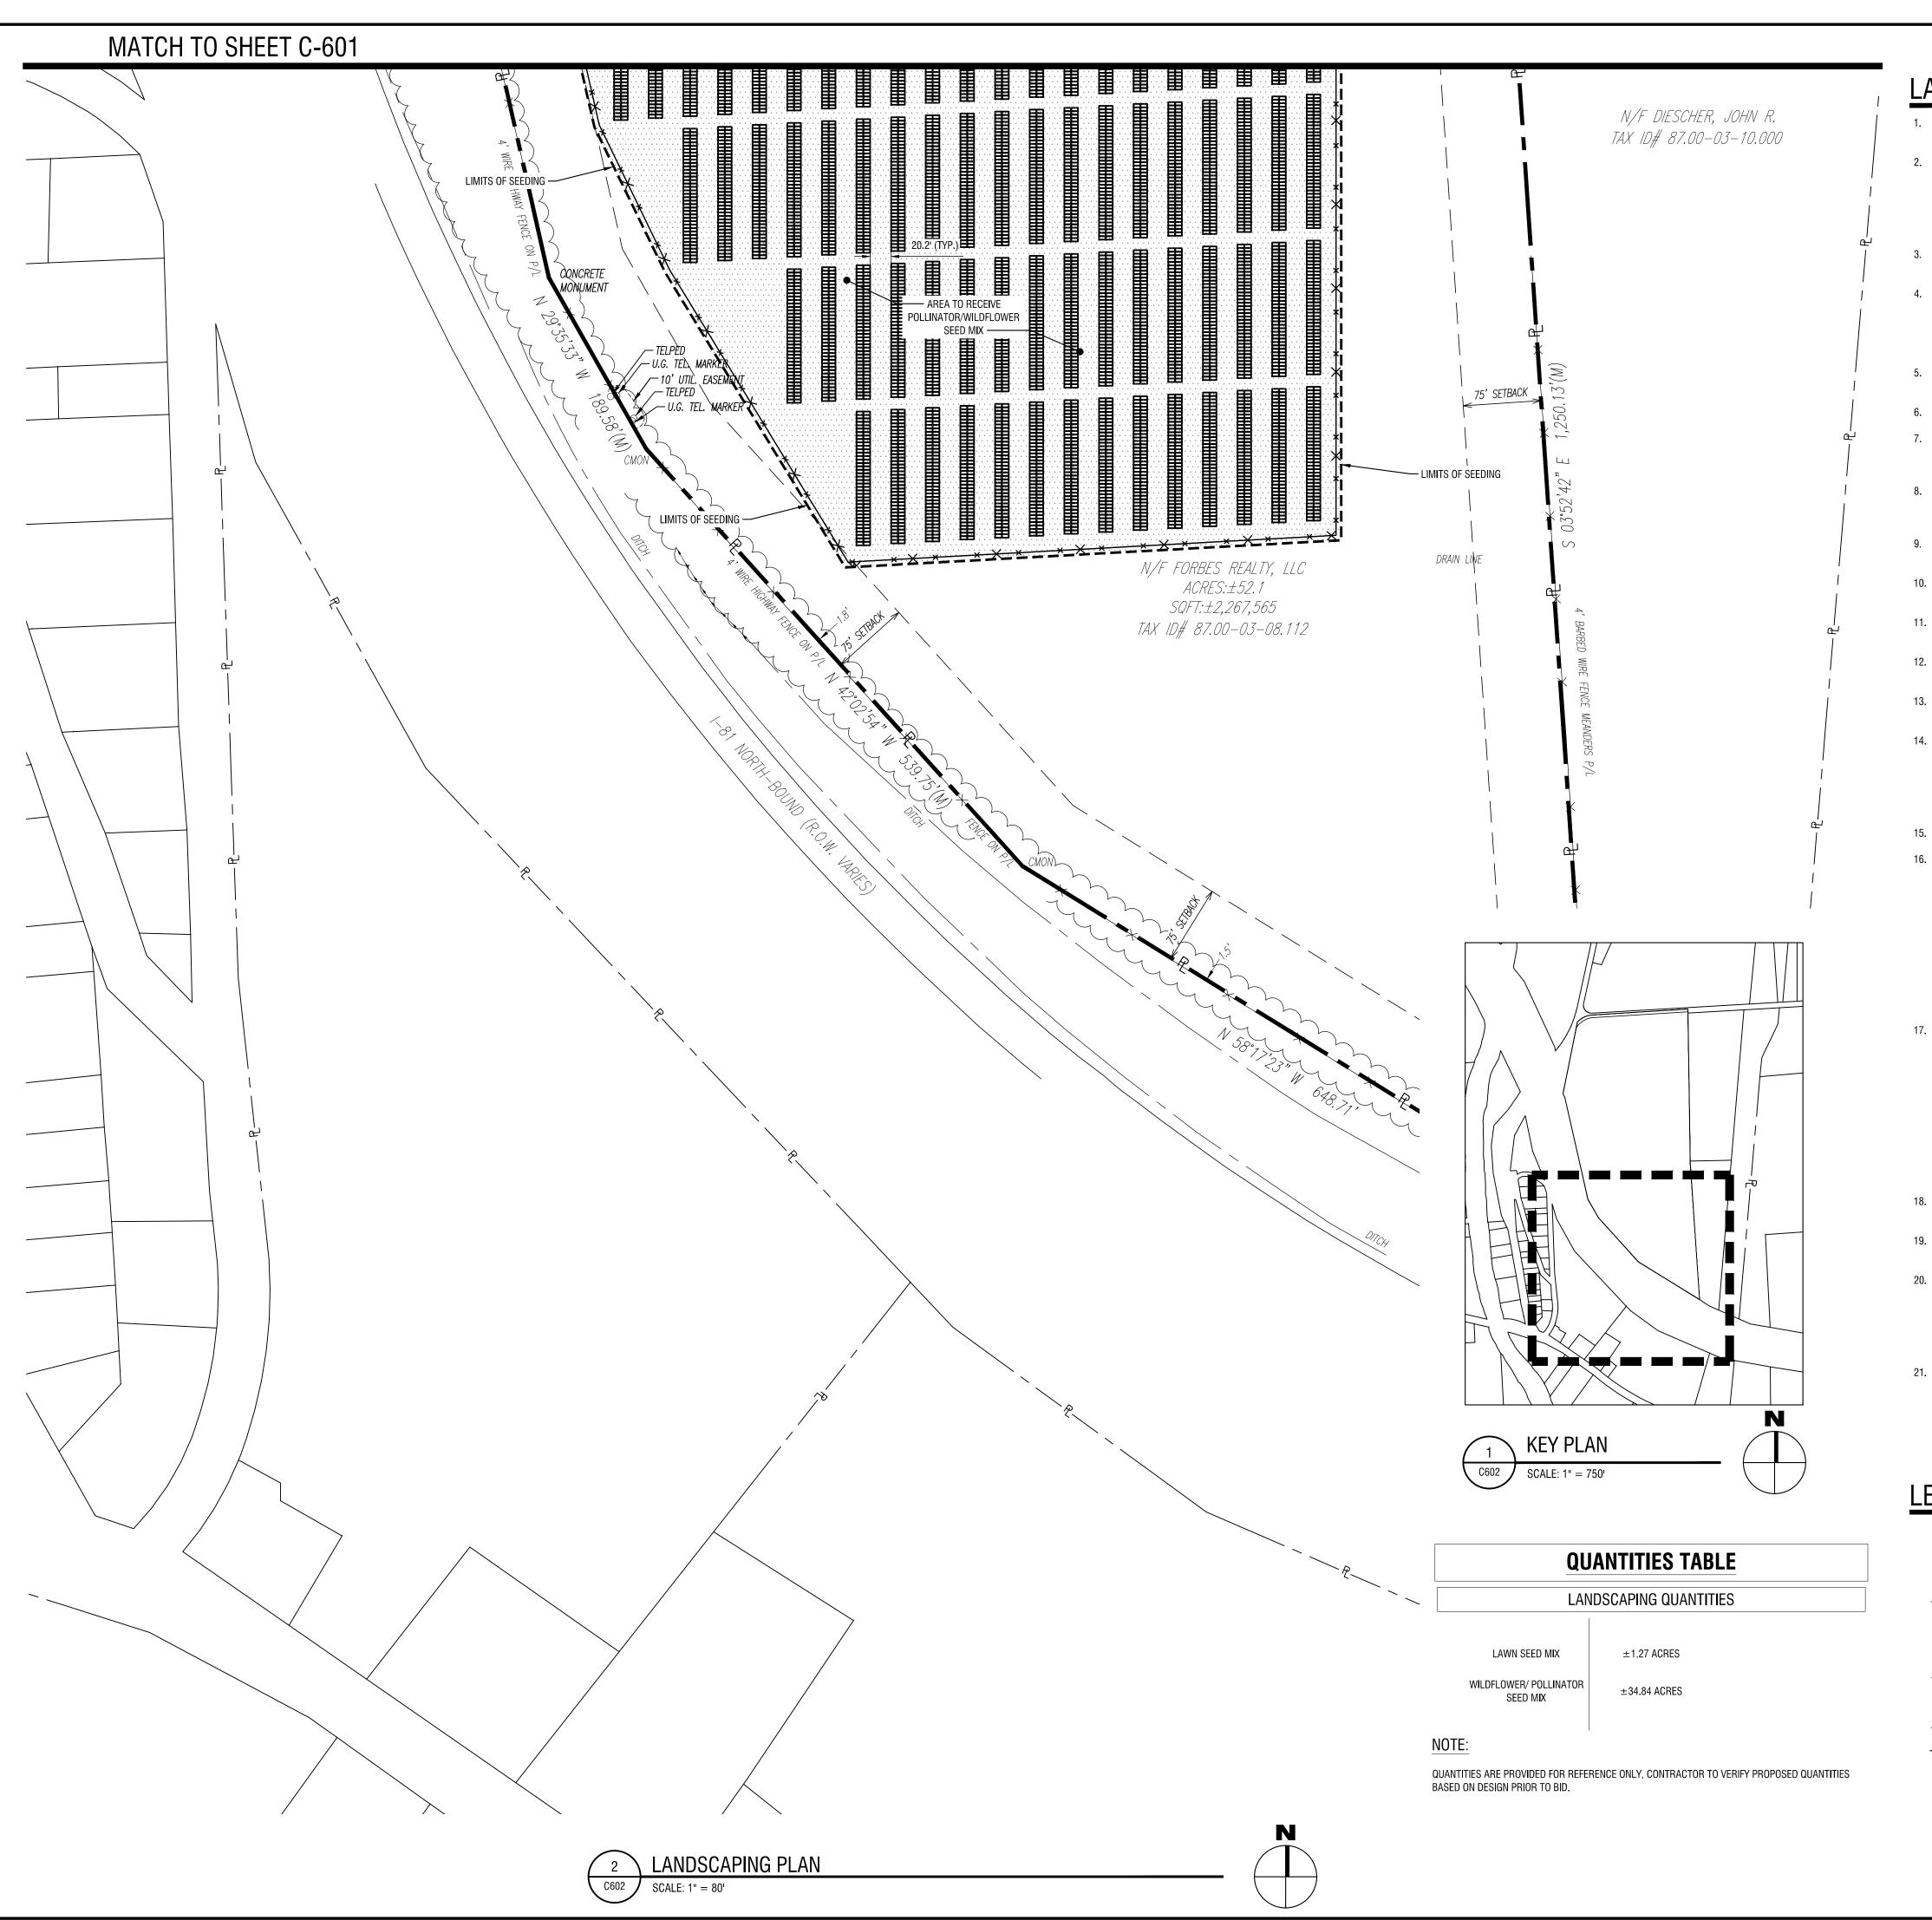
ISSUED FOR: REVIEW

DATE: **NOVEMBER 2020**

DRAWING NAME:

LANDSCAPING PLAN (SHEET 1 OF 2)

DRAWING NUMBER:



LANDSCAPING NOTES

- 1. ALL PLANTS SHALL MEET OR EXCEED THE MINIMUM REQUIREMENTS AS NOTED IN THE LATEST EDITION OF AMERICAN STANDARD FOR NURSERY STOCK BY AMERICAN ASSOCIATION OF NURSERYMEN, ANSI Z60.1.
- REPLACE, IN ACCORDANCE WITH THE DRAWINGS AND SPECIFICATIONS, ALL PLANTS THAT ARE MISSING, DEAD, OR DO NOT DEVELOP FROM PLANTING STOCK, OR AS DETERMINED BY THE CLIENT ARE IN UNHEALTHY OR UNSIGHTLY CONDITION, AND HAVE LOST THEIR NATURAL SHAPE DUE TO DEAD BRANCHES OR OTHER CAUSES DUE TO THE CONTRACTORS NEGLIGENCE. CONTRACTOR SHALL BEAR THE COST OF COMPLETE REPLACEMENT(S). IN CASE OF ANY QUESTIONS REGARDING THE CONDITION AND SATISFACTORY ESTABLISHMENT OF A REJECTED PLANT, THE LANDSCAPE ARCHITECT'S DECISION IS FINAL. PROVIDE A GUARANTEE FOR ALL REPLACEMENT PLANTS FOR AT LEAST ONE FULL GROWING SEASON.
- 3. REMOVE AND IMMEDIATELY REPLACE ALL PLANTS, AS DETERMINED BY THE CLIENT TO BE UNSATISFACTORY DURING THE INITIAL PLANTING INSTALLATION.
- 4. SHRUBS SHALL MEET THE REQUIREMENTS FOR HEIGHT INDICATED IN THE PLANT LIST. THE MEASUREMENTS FOR HEIGHT SHALL BE TAKEN FROM THE GROUND LEVEL TO THE AVERAGE HEIGHT OF THE TOP BRANCHES OF THE PLANT, AND NOT THE LONGEST BRANCH. SINGLE STEMMED OR THIN PLANTS WILL NOT BE ACCEPTED. SIDE BRANCHES SHALL BE GENEROUS, WELL TWIGGED, AND THE PLANT AS A WHOLE WELL SEATED IN THE GROUND. PLANTS SHALL BE IN A MOIST, VIGOROUS CONDITION, FREE FROM DEAD WOOD, BRUISES, OR OTHER ROOT OR BRANCH INJURIES.
- 5. A ONE YEAR GUARANTEE SHALL BE PROVIDED FOR ALL NEW AND RELOCATED PLANT MATERIALS FROM DATE OF FINAL ACCEPTANCE TO THE OWNER.
- 6. THE CONTRACTOR SHALL BE RESPONSIBLE FOR HIS OWN QUANTITY TAKEOFF.
- 7. THE CONTRACTOR SHALL PERFORM A ROUGH FIELD STAKE OUT OF ALL PLANT MATERIAL AND SHRUB BEDS. CONTACT THE ENGINEER FOR INSPECTION AND APPROVAL. LOCATIONS SHOWN ON THE PLAN CONVEY DESIGN INTENT ONLY. ACTUAL LOCATIONS WILL BE AS DIRECTED BY THE ENGINEER AT THE TIME OF INSTALLATION.
- 8. NAMES OF WOODY PLANT MATERIAL MUST COMPLY WITH "STANDARDIZED PLANT NAMES" AS ADOPTED BY THE LATEST EDITION OF THE AMERICAN JOINT COMMITTEE OF HORTICULTURAL NOMENCLATURE. PROVIDE STOCK TRUE TO BOTANICAL NAME AND LEGIBLY TAGGED.
- 9. SHOULD LOCATION OF TREES BE WITHIN 5' OF UNDERGROUND UTILITIES, RELOCATE SAID TREES TO MIN. OF 5' FROM ROOT BALL TO LITHLIFES
- 10. SHOULD LOCATIONS OF TREES OF LARGER SPECIES BE WITHIN 20' OF OVERHEAD WIRES, RELOCATE SAID TREES TO MIN. OF 20'
- 11. STAKE AND WRAP TREES IMMEDIATELY AFTER PLANTING. STAKES AND WRAPPING ARE TO BE REMOVED BY THE CONTRACTOR AT THE END OF THE GUARANTEE PERIOD.
- 12. MULCH ALL TREES AND SHRUB BEDS WITH 3" DOUBLE GROUND HARDWOOD BAR, COLOR: DARK BROWN. 'RIVER STONE' SURFACE
- SHALL BE SMOOTH, WASHED, GRADED GRAVEL, 1" TO 2" SIZE. PLACE ON FIBER MAT WEED BARRIER: MIRAFI 100X OR EQUAL.

 13. PLANTING BACK FILL MIXTURE: 4 PARTS TOP SOIL; 1 PART PEAT MOSS; 1/2 PART WELL ROTTED MANURE; 10 LBS. 5-10-5
- PLANTING FERTILIZER THOROUGHLY MIXED PER CUBIC YARD.

 14. TOPSOIL SHALL BE FURNISHED FROM THE STOCKPILED ON-SITE MATERIAL. ON-SITE MATERIAL IS TO BE MECHANICALLY SCREENED, ANYTHING LARGER THAN 0.5" SHALL BE REMOVED AND DISPOSED, IF AN INSUFFICIENT QUANTITY EXISTS, FURNISH
- SCREENED, ANYTHING LARGER THAN 0.5" SHALL BE REMOVED AND DISPOSED. IF AN INSUFFICIENT QUANTITY EXISTS, FURNISH FROM OFF-SITE SOURCES IN QUANTITIES SUFFICIENT TO COMPLETE THE REQUIREMENTS AS SPECIFIED. TOPSOIL SHALL BE NATURAL, FRIABLE, FERTILE SOIL, CHARACTERISTIC OF PRODUCTIVE SOIL IN THE VICINITY, FREE FROM STONES, CLAY LUMPS, ROOTS AND OTHER FOREIGN MATTER WITH AN ACIDITY BETWEEN 6.0 AND 6.8 ph. PROPOSED TOPSOIL MATERIAL FROM OFF-SITE SOURCES SHALL BE MECHANICALLY SCREENED SUBJECT TO APPROVAL BY THE ENGINEER.
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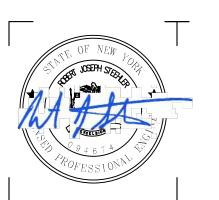
LEGEND

EXISTING	PROPOSED	DESCRIPTION
<u> </u>		WETLAND
		ROADWAY CENTERLINES
		GRAVEL PAVEMENT
		CHAIN LINK FENCE
		TREELINE
BLDG		BUILDING/STRUCTURE
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	♡ *	TREE
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		LAWN SEED MIX
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700 UNIVERSE BLVD. JUNO BEACH, FL 33408



2020 NY GREENFIELD PV DESIGN - RILEY ROAD 1

1902 RILEY RD. CORTLANDVILLE, NY 13045

NO:	DATE:	DESCRIPTION:
Revisions		

PROJECT NUMBER: 2201200.08

DRAWN BY:

REVIEWED BY:

REVIEW

NOVEMBER 2020

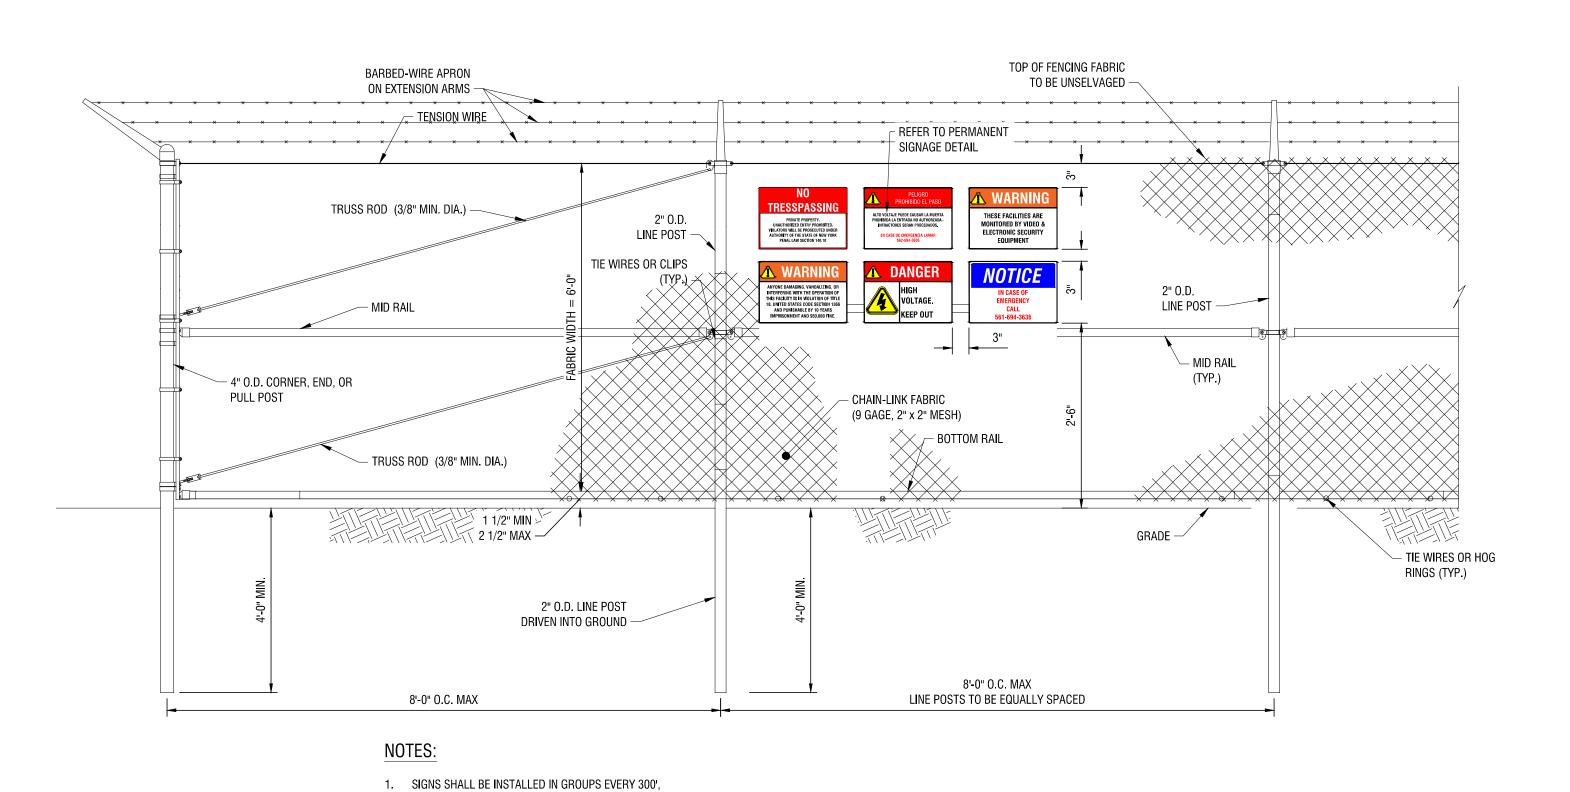
DRAWING NAME:

ISSUED FOR:

DATE:

LANDSCAPING PLAN (SHEET 2 OF 2)

DRAWING NUMBER:



SIGNAGE DETAIL

6' HIGH BARBED WIRE HIGH SECURITY FENCE (IN WETLANDS)

BARBED-WIRE APRON

STRETCHER BARS (TYP.)

/ 3" CLEAR (TYP.)

6' TALL WIDE DOUBLE SWING GATE

- 5,000 PSI

CONCRETE

SEE PLANS FOR GATE WIDTH.

ON EXTENSION ARMS —

LATCH AND PADLOCK-

WARNING

ANYONE DAMAGING, VANDALIZING, OR INTERFERING WITH THE OPERATION OF THIS FACILITY IS IN VIOLATION OF TITLE 18. UNITED STATES CODE SECTION 1366 AND PUNISHABLE BY 10 YEARS IMPRISONMENT AND \$50,000 FINE.

DANGER VOLTAGE. KEEP OUT

WARNING

THESE FACILITIES ARE MONITORED BY VIDEO & **ELECTRONIC SECURITY EQUIPMENT**

NOTICE

IN CASE OF EMERGENCY CALL 561-694-3636

RILEY ROAD **SOLAR ARRAY**

1902 RILEY ROAD, **CORTLANDVILLE, NY** 13045

NO **TRESSPASSING**

PRIVATE PROPERTY. UNAUTHORIZED ENTRY PROHIBITED. **VIOLATORS WILL BE PROSECUTED UNDER AUTHORITY OF THE STATE OF NEW YORK** PENAL LAW SECTION 140.10





LITHIUM-ION BATTERIES. FIRE AND EXPLOSION

NOT OPEN DOORS WITH OCC AUTHORIZATION

DANGER

ALARM INDICATES FIRE SYSTEM IS ACTIVE. LITHIUM-ION BATTERIES. FIRE AND EXPLOSION RISK.

DO NOT OPEN DOORS WITH ROCC **AUTHORIZATION 561-694-3636**



PELIGRO PROHIBIDO EL PASO

ALTO VOLTAJE PUEDE CAUSAR LA MUERTA PHOHIBIDA LA ENTRADA NO AUTHORZADA -**INFRACTORES SERAN PROCEDADOS.**

> **EN CASE DE EMERGENCIA LAMAR** 562-694-3636

1. ALL SIGNS TO BE 18" x 24" IN SIZE

SIGNS SHALL BE UV RESISTANT AND IN COLOR. SIGN MATERIAL SHALL BE HDPE OR LIGHT GAGE GALVANIZED STEEL

3. SIGNS TO BE ATTACHED TO FENCING WITH PERMANENT FASTENERS.

PERMANENT SIGNAGE

- TOP OF FENCING FABRIC TO BE UNSELVAGED -LATCH IN OPEN POSITION -LATCH IN CLOSED POSITION

TOP OF FENCING FABRIC BARBED-WIRE APRON TO BE UNSELVAGED -TRUSS ROD (3/8" MIN. DIA.) LINE POST TIE WIRES OR CLIPS 2" O.D. LINE POST — 4" O.D. CORNER, END, OR PULL POST -— MID RAIL - CHAIN-LINK FABRIC (9 GAGE, 2" x 2" MESH) TRUSS ROD (3/8" MIN. DIA.) 1 1/2" MIN > 2 1/2" MAX -GRADE -— TIE WIRES OR HOG RINGS (TYP.) 18" MIN. DIA. 2" O.D. LINE POST DRIVEN INTO GROUND 5,000 PSI CONCRETE -8'-0" O.C. MAX 8'-0" O.C. MAX LINE POSTS TO BE EQUALLY SPACED

1. SIGNS SHALL BE INSTALLED IN GROUPS EVERY 300', 6' HIGH BARBED WIRE HIGH SECURITY FENCE

CONSTRUCTION DETAILS

300 State Street, Suite 201

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NEXT ERA ENERGY

700 UNIVERSE BLVD. JUNO BEACH, FL 33408

NEXTera

ENERGY

2020 NY GREENFIELD PV

DESIGN - RILEY ROAD 1

1902 RILEY RD. CORTLANDVILLE, NY 13045

2201200.08

REVIEW

NOVEMBER 2020

DESCRIPTION:

Rochester, NY 14614

585-454-6110

labellapc.com

DRAWING NUMBER:

NO: DATE:

PROJECT NUMBER:

DRAWN BY:

REVIEWED BY

ISSUED FOR:

DRAWING NAME:

DATE:

HINGE (TYP.)

2.5" O.D. POST -

4" O.D. END AND

CORNER POST

9 GA, 2"x2"

MESH FABRIC -

1. CAN BE TWO STACKED BALES OR PARTIALLY EXCAVATED TO REACH 3 FT DEPTH

CONSTRUCTION SPECIFICATIONS

- 1. LOCATE WASHOUT STRUCTURE A MINIMUM OF 100 FEET AWAY FROM OPEN CHANNELS, STORM DRAIN INLETS, SENSITIVE AREAS, WETLANDS,
- BUFFERS AND WATER COURSES AND AWAY FROM CONSTRUCTION TRAFFIC. 2. SIZE WASHOUT STRUCTURE FOR VOLUME NECESSARY TO CONTAIN WASH WATER AND SOLIDS AND MAINTAIN AT LEAST 4 INCHES OF FREEBOARD. TYPICAL DIMENSIONS ARE 10 FEET X 10 FEET X 3 FEET DEEP.
- 3. PREPARE SOIL BASE FREE OF ROCKS OR OTHER DEBRIS THAT MAY CAUSE TEARS OR HOLES IN THE LINER. FOR LINER, USE 10 MIL OR THICKER UV RESISTANT, IMPERMEABLE SHEETING, FREE OF HOLES AND TEARS OR OTHER DEFECTS THAT COMPROMISE IMPERMEABILITY OF THE MATERIAL.
- 4. PROVIDE A SIGN FOR THE WASHOUT IN CLOSE PROXIMITY TO THE FACILITY. 5. KEEP CONCRETE WASHOUT STRUCTURE WATER TIGHT. REPLACE IMPERMEABLE LINER IF DAMAGED (E.G., RIPPED OR PUNCTURED). EMPTY OR
- REPLACE WASHOUT STRUCTURE THAT IS 75 PERCENT FULL, AND DISPOSE OF ACCUMULATED MATERIAL PROPERLY. DO NOT REUSE PLASTIC LINER. WET-VACUUM STORED LIQUIDS THAT HAVE NOT EVAPORATED AND DISPOSE OF IN AN APPROVED MANNER. PRIOR TO FORECASTED RAINSTORMS, REMOVE LIQUIDS OR COVER STRUCTURE TO PREVENT OVERFLOWS. REMOVE HARDENED SOLIDS, WHOLE OR BROKEN UP, FOR DISPOSAL OR RECYCLING. MAINTAIN RUNOFF DIVERSION AROUND EXCAVATED WASHOUT STRUCTURE UNTIL STRUCTURE IS REMOVED.

CONCRETE WASHOUT AREA WITH STRAW BALES

、C-702 / N.T.S.

SILT FENCE C-702 / NYS DEC DETAIL: SILT FENCE

WOVEN WIRE FENCE (MIN. 14 1/2 GAUGE W/ MAX. 6" MESH SPACING WITH FILTER CLOTH -

WOVEN WIRE FENCE (MIN. 14 1/2 GAUGE W/

MAX. 6" MESH SPACING WITH FILTER CLOTH -

FLOW

EMBED FILTER CLOTH A MIN. OF 6" IN GROUND —

FENCE SHALL BE WOVEN WIRE, 6" MAXIMUM MESH OPENING.

4. PREFABRICATED UNITS SHALL BE GEOFAB, ENVIROFENCE, OR APPROVED EQUAL.

EITHER "T" OR "U" TYPE OR HARDWOOD.

COMPACTED SOIL -

FILTER CLOTH SHALL BE EITHER FILTER X, MIRAFI 100X, STABLINKA 140N, OR APPROVED EQUAL.

SECTION VIEW

2. FILTER CLOTH TO BE FASTENED SECURELY TO WOVEN WIRE FENCE WITH TIES SPACED EVERY 24" AT TOP AND MID SECTION.

WHEN TWO SECTIONS OF FILTER CLOTH ADJOIN EACH OTHER THEY SHALL BE OVER-LAPPED BY SIX INCHES AND FOLDED.

MAINTENANCE SHALL BE PERFORMED AS NEEDED AND MATERIAL REMOVED WHEN "BULGES" DEVELOP IN THE SILT FENCE.

1. WOVEN WIRE FENCE TO BE FASTENED SECURELY TO FENCE POSTS WITH WIRE TIES OR STAPLES. POSTS SHALL BE STEEL

10' MAX. C. TO C.

PERSPECTIVE VIEW

— 36" MIN. FENCE POST

— UNDISTURBED

GROUND

– 36" MIN. FENCE

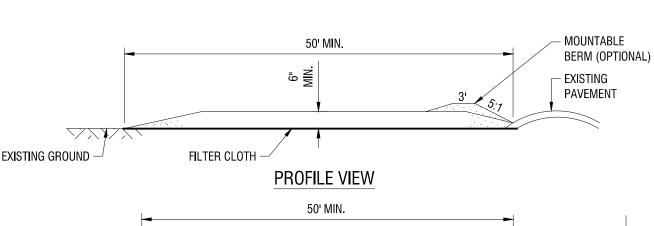
POSTS, DRIVEN MIN.

16" INTO GROUND

 $^{-}$ 1 $\frac{1}{4}$ " SQUARE HARDWOOD

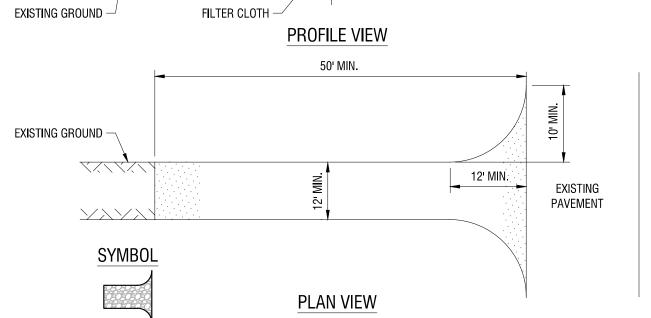
MIN. SLOPE MIN. SLOPE NOTES: 1. AREA CHOSEN FOR STOCKPILING OPERATIONS SHALL BE DRY AND STABLE. 2. MAXIMUM SLOPE OF STOCKPILE SHALL BE 1V:2H.

TEMPORARY SOIL STOCKPILE



3. UPON COMPLETION OF SOIL STOCKPILING, EACH PILE SHALL BE SURROUNDED WITH

SILT FENCING, THEN STABILIZED WITH VEGETATION OR COVERED.



CONSTRUCTION SPECIFICATIONS:

- 1. STONE SIZE USE 1-4 INCH STONE, OR RECLAIMED OR RECYCLED CONCRETE EQUIVALENT.
- 2. LENGTH NOT LESS THAN 50 FEET (EXCEPT ON A SINGLE RESIDENCE LOT WHERE A 30 FOOT MINIMUM LENGTH WOULD APPLY).
- 3. THICKNESS NOT LESS THAN SIX (6) INCHES. 4. WIDTH - TWELVE (12) FOOT MINIMUM, BUT NOT LESS THAN THE FULL WIDTH AT POINTS WHERE INGRESS OR EGRESS
- OCCURS. TWENTY-FOUR (24) FOOT IF SINGLE ENTRANCE TO SITE.
- 5. GEOTEXTILE WILL BE PLACED OVER THE ENTIRE AREA PRIOR TO PLACING OF STONE. 6. SURFACE WATER - ALL SURFACE WATER FLOWING OR DIVERTED TOWARD CONSTRUCTION ACCESS SHALL BE PIPED
- BENEATH THE ENTRANCE. IF PIPING IS IMPRACTICAL, A MOUNTABLE BERM WITH 5:1 SLOPES WILL BE PERMITTED. MAINTENANCE - THE ENTRANCE SHALL BE MAINTAINED IN A CONDITION WHICH WILL PREVENT TRACKING OR
- FLOWING OF SEDIMENT ONTO PUBLIC RIGHT OF WAY, ALL SEDIMENT SPILLED, DROPPED, WASHED, OR TRACKED ONTO PUBLIC RIGHTS OF WAY MUST BE REMOVED IMMEDIATELY. 8. WHEN WASHING IS REQUIRED, IT SHALL BE DONE ON AN AREA STABILIZED WITH STONE AND WHICH DRAINS INTO AN
- APPROVED SEDIMENT TRAPPING DEVICE. 9. PERIODIC INSPECTION AND NEEDED MAINTENANCE SHALL BE PROVIDED AFTER EACH RAIN EVENT.

STABILIZED CONSTRUCTION ENTRANCE

C-702 / N.YS DEC DETAIL: STABILIZED CONSTRUCTION ACCESS

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1902 RILEY RD. CORTLANDVILLE, NY 13045

NO: DATE: DESCRIPTION: Revisions PROJECT NUMBER:

2201200.08 DRAWN BY: BER REVIEWED BY:

ISSUED FOR: REVIEW

DATE: NOVEMBER 2020

CONSTRUCTION DETAILS

DRAWING NUMBER:

DRAWING NAME:

GENERAL NOTES:

- 1. PROVIDE A 4800 LB/FT ENCHANCED WOVEN GEOTEXTILE SEPERATION LAYER AND INSTALL PERMANUFACTURER RECOMMENDATIONS INCLUDING OVERLAPS BASED ON SUB GRADE CBR.
- 2. THE GEOWEB PANELS SHALL BE CONNECTED WITH ATRA KEYS OF EACH INTERLEAF AND END TO END CONNECTION.
- 3. PROVIDE ATRA ANCHORS TO KEEP PANELS OPEN FOR INFILL AS REQUIRED.
- 4. GEOWEB INFILL SHALL BE 3/4" TO 1.5" CRUSHED AGGREGATE WITH FINES LIMITED TO LESS THAN 10% TO ALLOW FREE DRAINAGE.
- 5. LIMIT THE DROP OF INFILL TO PREVENT PANEL DISTORTION.
- 6. ASSUME HS-20 LOADING.

PERMEABLE ACCESS ROAD GENERAL NOTES:

- 1. USE OF THIS DETAIL/CRITERION IS LIMITED TO ACCESS ROADS USED ON AN OCCASIONAL BASIS ONLY (I.E. PROVIDE ACCESS FOR MOWING EQUIPMENT REPAIR OR MAINTENANCE, ETC.)
- 2. LIMITED USE PERVIOUS ACCESS ROAD IS LIMITED TO LOW IMPACT IRREGULAR MAINTENANCE ACCESS ASSOCIATED WITH RENEWABLE ENERGY PROJECTS IN NEW YORK STATE.
- 3. REMOVE STUMPS, ROCKS AND DEBRIS AS NECESSARY, FILL VOIDS TO MATCH EXISTING NATIVE SOILS AND COMPACTION LEVEL.
- 4. REMOVED TOPSOIL MAY BE SPREAD IN ADJACENT AREAS AS DIRECTED BY THE PROJECT ENGINEER. COMPACT TO THE DEGREE OF THE NATIVE INSITU SOIL. DO NOT PLACE IN AN AREA THAT IMPEDES STORMWATER DRAINAGE.
- 5. GRADE ROADWAY, WHERE NECESSARY, TO NATIVE SOIL AND DESIRED ELEVATION. MINOR GRADING FOR CROSS SLOPE CUT AND FILL MAY BE REQUIRED.
- 6. REMOVE REFUSE SOILS AS DIRECTED BY THE PROJECT ENGINEER. DO NOT PLACE IN AN AREA THAT IMPEDES STORMWATER DRAINAGE.
- 7. ROADWAY WIDTH TO BE DETERMINED BY CLIENT.
- 8. THE LIMITED USE PERVIOUS ACCESS ROAD CROSS SLOPE SHALL BE 2% IN MOST CASES AND SHOULD NOT EXCEED 5%. THE LONGITUDINAL SLOPE OF THE ACCESS DRIVE SHOULD NOT EXCEED 15%.
- 9. LIMITED USE PERVIOUS ACCESS ROAD IS NOT INTENDED TO BE UTILIZED FOR CONSTRUCTION WHICH MAY SUBJECT THE ACCESS TO SEDIMENT TRACKING. THIS SPECIFICATION IS TO BE DEVELOPED FOR POST-CONSTRUCTION USE, SOIL RESTORATION PRACTICES MAY BE APPLICABLE TO RESTORE CONSTRUCTION RELATED COMPACTION TO PRE-EXISTING CONDITIONS AND SHOULD BE VERIFIED BY SOIL PENETROMETER READINGS. THE PENETROMETER READINGS SHALL BE COMPARED TO THE RESPECTIVE RECORDED READINGS TAKEN PRIOR TO CONSTRUCTION, EVERY 100 LINEAR FEET ALONG THE PROPOSED ROADWAY.
- 10. TO ENSURE THAT SOIL IS NOT TRACKED ONTO THE LIMITED USE PERVIOUS ACCESS ROAD, IT SHALL NOT BE USED BY CONSTRUCTION VEHICLES TRANSPORTING SOIL, FILL MATERIAL, ETC. IF THE LIMITED USE PERVIOUS ACCESS IS COMPLETED DURING INITIAL PHASES OF CONSTRUCTION, A STANDARD NEW YOK STATE STABILIZED CONSTRUCTION ACCESS SHALL BE CONSTRUCTED AND UTILIZED TO REMOVE SEDIMENT FROM CONSTRUCTION VEHICLES AND EQUIPMENT PRIOR TO ENTERING THE LIMITED USE PERVIOUS ACCESS ROAD FROM ANY LOCATION ON, OR OFF SITE. MAINTENANCE OF THE PERVIOUS ACCESS ROAD WILL BE REQUIRED IF SEDIMENT IS OBSERVED WITHIN THE CLEAN STONE.
- 11. THE LIMITED USE PERVIOUS ACCESS ROAD SHALL NOT BE CONSTRUCTED OR USED UNTIL ALL AREAS SUBJECT TO RUNOFF ONTO THE PERVIOUS ACCESS HAVE ACHIEVED FINAL STABILIZATION.
- 12. PROJECTS SHOULD AVOID INSTALLATION OF THE LIMITED USE PERVIOUS ACCESS ROAD IN POORLY DRAINED AREAS, HOWEVER IF NO ALTERNATIVE LOCATION IS AVAILABLE, THE PROJECT SHALL UTILIZE WOVEN GEOTEXTILE MATERIAL AS DETAILED IN FOLLOWING NOTES.
- 13. THE DRAINAGE DITCH IS OFFERED IN THE DETAIL FOR CIRCUMSTANCES WHEN CONCENTRATED FLOW COULD NOT BE AVOIDED. THE INTENTION OF THIS DESIGN IS TO MINIMIZE ALTERATIONS TO HYDROLOGY, HOWEVER WHEN DEALING WITH 5%-15% GRADES NOT PARALLEL TO THE CONTOUR, A ROADSIDE DITCH MAY BE REQUIRED. THE NYS STANDARDS AND SPECIFICATIONS FOR EROSION AND SEDIMENT CONTROLS FOR GRASSED WATERWAYS AND VEGETATED WATERWAYS ARE APPLICABLE FOR SIZING AND STABILIZATION. DIMENSIONS FOR THE GRASSED WATERWAY SPECIFICATION WOULD BE DESIGNED FOR PROJECT SPECIFIC HYDROLOGIC RUNOFF CALCULATIONS, AND A SEPARATE DETAIL FOR THE SPECIFIC GRASSED WATERWAY WOULD BE INCLUDED IN THIS PRACTICE. RUNOFF DISCHARGES WILL BE SUBJECT TO THE OUTLET REQUIREMENTS OF THE REFERENCED STANDARD. INCREASED POST-DEVELOPMENT RUNOFF FROM THE ASSOCIATED ROADSIDE DITCH MAY REQUIRE ADDITIONAL PRACTICES TO ATTENUATE RUNOFF TO PRE-DEVELOPMENT CONDITIONS.
- 14. IF A ROADSIDE DITCH IS NOT UTILIZED TO CAPTURE RUNOFF FROM THE ACCESS ROAD, THE PERVIOUS ACCESS ROAD WILL HAVE A WELL-ESTABLISHED PERENNIAL VEGETATIVE COVER, WHICH SHALL CONSIST OF UNIFORM VEGETATION (I.E. BUFFER), 20 FEET WIDE AND PARALLEL TO THE DOWN GRADIENT SIDE OF THE ACCESS ROAD. POST-CONSTRUCTION OPERATION AND MAINTENANCE PRACTICES WILL MAINTAIN THIS VEGETATIVE COVER TO ENSURE FINAL STABILIZATION FOR THE LIFE OF THE ACCESS ROAD.
- 15. THE DESIGN PROFESSIONAL MUST ACCOUNT FOR THE LIMITED USE PERVIOUS ACCESS ROAD IN THEIR SITE ASSESSMENT/HYDROLOGY ANALYSIS. IF THE HYDROLOGY ANALYSIS SHOWS THAT THE HYDROLOGY HAS BEEN ALTERED FROM PRE- TO POST-DEVELOPMENT CONDITIONS (SEE APPENDIX A OF GP-0-20-001 FOR THE DEFINITION OF "ALTER THE HYDROLOGY..."), THE DESIGN MUST INCLUDE THE NECESSARY DETENTION/RETENTION PRACTICES TO ATTENUATE THE RATES (10 AND 100 YEAR EVENTS) TO PRE-DEVELOPMENT CONDITIONS.

GEOGRID MATERIAL NOTES:

- 1. THE GEOGRID, OR COMPARABLE PRODUCT, IS INTENDED FOR USE FOR ALL CONDITIONS, IN ORDER TO ASSIST IN MATERIAL SEPARATION FROM NATIVE SOILS AND PRESERVE ACCESS LOADS.
- 2. GRAVEL FILL MATERIAL SHALL CONSIST OF 1-4" CLEAN, DURABLE, SHARP-ANGLED CRUSHED STONE OF UNIFORM QUALITY, MEETING THE SPECIFICATIONS OF NYSDOT ITEM 703-02, SIZE DESIGNATION 3-5 OF TABLE 703-4. STONE MAY BE PLACED IN
- FRONT OF, AND SPREAD WITH, A TRACKED VEHICLE. GRAVEL SHALL NOT BE COMPACTED.

 3. GEOGRID SHALL BE MIRAFI BXG110 OR APPROVED EQUAL. GEOGRID SHALL BE DESIGNED BASED ON EXISTING SOIL CONDITIONS AND PROPOSED HAUL ROAD SLOPES.
- 4. IF MORE THAN ONE ROLL WIDTH IS REQUIRED, ROLLS SHOULD OVERLAP A MINIMUM OF SIX INCHES.
- 4. IF MORE THAN ONE ROLL WIDTH IS REQUIRED, ROLLS SHOULD OVERLAP A MINIMON CO.

 5. REFER TO MANUFACTURER'S SPECIFICATION FOR PROPER TYING AND CONNECTIONS.
- 6. LIMITED USE PERVIOUS ACCESS ROAD SHALL BE TOP DRESSED AS REQUIRED WITH ONLY 1-4" CRUSHED STONE MEETING NYSDOT ITEM 703-02 SPECIFICATIONS.

BASIS OF DESIGN: TENCATE MIRAFI BXG110 GEOGRIDS; 365 SOUTH HOLLAND DRIVE, PENDERGRASS, GA; 800-685-9990 OR 706-693-2226; WWW.MIRAFI.COM

GEOWEB MATERIAL NOTES:

- 1. THE GEOWEB, OR COMPARABLE PRODUCT, IS SUGGESTED FOR USE ON ROAD PROFILES EXCEEDING 10%. THE GEOWEB PRODUCT IS INTENDED TO LIMIT SHIFTING STONE MATERIAL DURING USE.
- 2. INSTALLATION TO BE COMPLETED IN ACCORDANCE WITH MANUFACTURER'S SPECIFICATIONS.
- 3. WHERE REQUIRED, A NATIVE SOIL WEDGE SHALL BE PLACED TO ACCOMMODATE ROAD CROSS SLOPE OF 2%. NATIVE SOIL SHALL BE COMPACTED TO MATCH EXISTING SOIL CONDITIONS.
- 4. GRAVEL FILL MATERIAL SHALL CONSIST OF 1-4" CLEAN, DURABLE, SHARP-ANGLED CRUSHED STONE OF UNIFORM QUALITY, MEETING THE SPECIFICATIONS OF NYSDOT ITEM 703-02, SIZE DESIGNATION 3-5 OF TABLE 703-4. STONE MAY BE PLACED IN FRONT OF, AND SPREAD WITH, A TRACKED VEHICLE. GRAVEL SHALL NOT BE COMPACTED.
- 5. GEOWEB SYSTEM SHALL BE PRESTO GEOSYSTEM GEOWEB OR APPROVED EQUAL. GEOWEB SHALL BE DESIGNED BASED ON EXISTING SOIL CONDITIONS AND PROPOSED HAUL ROAD SLOPES.
- 6. LIMITED USE PERVIOUS ACCESS ROAD SHALL BE TOP DRESSED AS REQUIRED WITH ONLY 1-4" CRUSHED STONE, SIZE 3A, MEETING NYSDOT ITEM 703-02 SPECIFICATIONS.
- 7. THE TOP EDGES OF ADJACENT CELL WALLS SHALL BE FLUSH WHEN CONNECTING. ALIGN THE I-SLOTS FOR INTERLEAF AND END TO END CONNECTIONS. THE GEOWEB PANELS SHALL BE CONNECTED WITH ATRA KEYS AT EACH INTERLEAD AND END TO END CONNECTIONS. REFER TO MANUFACTURER'S SPECIFICATION FOR PROPER INSTALLATION, TYING AND CONNECTIONS.
- 8. PREPARE THE SUBGRADE AS SHOWN ON THE CONSTRUCTION DRAWINGS.
- 9. COMPACT THE SOIL TO A MINIMUM 95% STANDARD PROCTOR.
- 10. VERIFY THAT THE SUBGRADE STRENGTH. IF UNACCEPTABLE, THE SOILS SHALL BE REMOVED AND REPLACED AS DIRECTED BY THE ENGINEER.
- 11. WHERE REQUIRED, PROVIDE GEOTEXTILE SEPARATION LAYER.
- 12. EXPAND THE GEOWEB SECTIONS INTO POSITION AND CONNECT THE END TO END INTERLEAF CONNECTIONS WITH ATRA KEYS.
- 13. PLACE THE SPECIFIED INFILL MATERIAL TO 2 INCHES ABOVE CELL WALLS AND COMPACT TO A MINIMUM 95% STANDARD PROCTOR.
- 14. PROVIDE ADDITIONAL SURFACE MATERIAL, AS SPECIFIED.
- BASIS OF DESIGN: PRESTO GEOSYSTEMS GEOWEB; 670 NORTH PERKINS STREET, APPLETON, WI; 800-548-3424 OR 920-738-1222; INFOR@PRESTOGEO.COM; WWW.PRESTOGEO.COM

WOVEN GEOTEXTILE MATERIAL NOTES:

- 1. SPECIFIED GEOTEXTILE WILL ONLY BE UTILIZED IN PLACID SOILS. PLACID SOILS CONSIST OF POORLY DRAINED SOILS COMPOSED OF FINELY TEXTURED PARTICLES AND ARE PRONE TO RUTTING. PLACID SOILS ARE TYPICALLY PRESENT IN LOW-LYING AREAS WITH HYDROLOGIC SOILS GROUP (HSG) OF C OR D, OR AS SPECIFIED FROM AN ENVIRONMENTAL SCIENTIST, SOIL SCIENTIST, OR GEOTECHNICAL DATA.
- 2. THE CONCERN FOR POTENTIAL REDUCTION OF NATIVE INFILTRATION RATES DUE TO THE GEOTEXTILE MATERIAL WOULD NOT BE A SIGNIFICANT CONCERN IN POORLY DRAINED SOILS WHERE SEGREGATION OF PERVIOUS STONE AND NATIVE MATERIALS IS CRUCIAL FOR LONG TERM OPERATION AND MAINTENANCE.

BASIS OF DESIGN: TENCATE MIRAFI RSI-SERIES WOVEN GEOSYNTHETICS; 365 SOUTH HOLLAND DRIVE, PENDERGRASS, GA; 800-685-9990 OR 706-693-2226; WWW.MIRAFI.COM

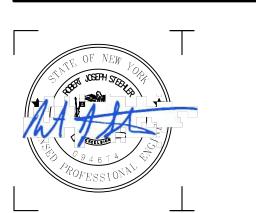
1 LIMITED USE

LIMITED USE PERVIOUS ACCESS ROAD - 0% TO 10% SLOPES

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NEXT ERA ENERGY

700 UNIVERSE BLVD. JUNO BEACH, FL 33408



2020 NY GREENFIELD PV DESIGN - RILEY ROAD 1

1902 RILEY RD. CORTLANDVILLE, NY 13045

NO:	DATE:	DESCRIPTION:
Revisions		

PROJECT NUMBER:

2201200.08

DRAWN BY:
BER
REVIEWED BY:
DG

ISSUED FOR:

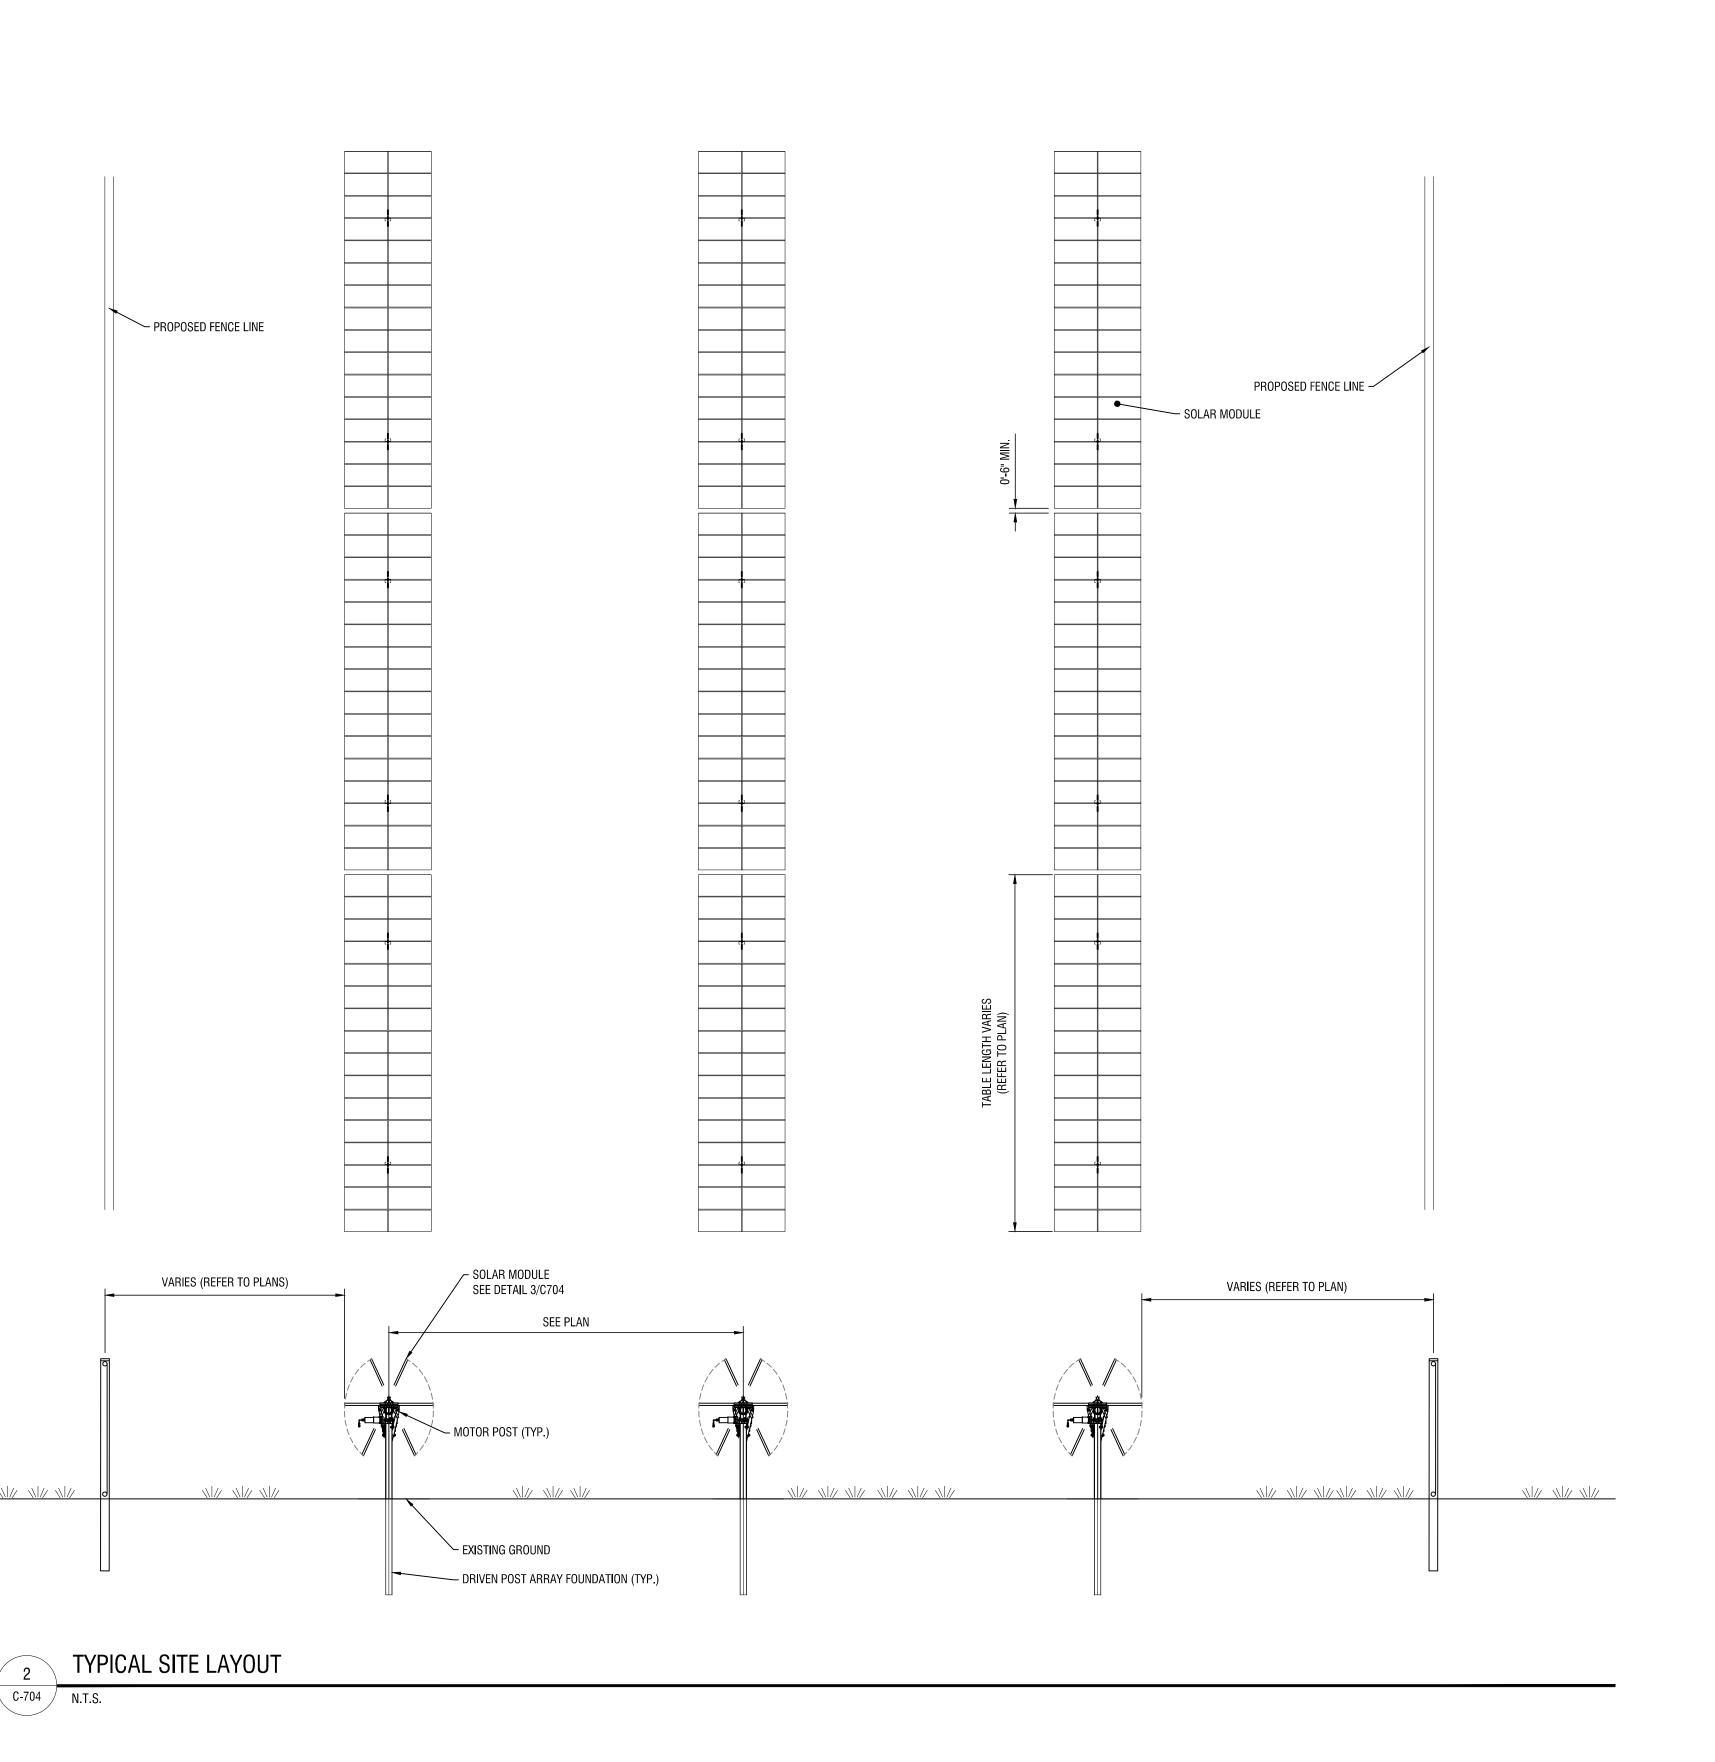
DATE: NOVEMBER 2020

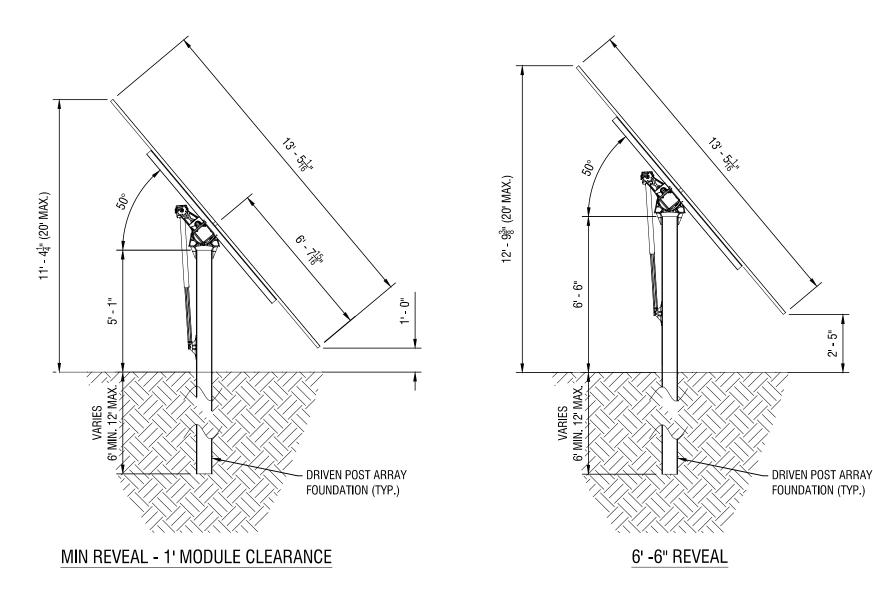
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CONSTRUCTION DETAILS

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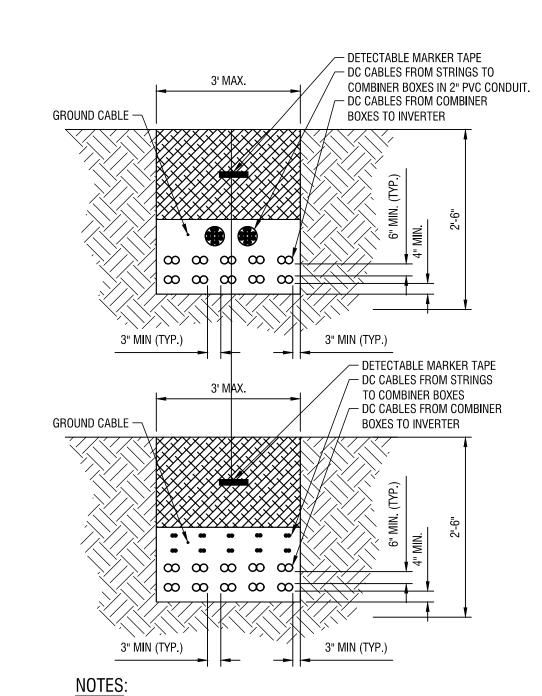
DRAWING NAME:





SOLAR MODULE AND FRAME PROFILE

C-704 N.T.S.



TRENCH NOTES:

- 1. ADDITIONAL MISCELLANEOUS CABLES FROM FIELD DEVICES SUCH AS TEMPERATURE TRANSMITTERS, METEOROLOGICAL STATIONS, REFERENCE MODULES, SIGNAL, GROUND SHALL UTILIZE THE UNDERGROUND TRENCH SYSTEM WHERE IT IS APPLICABLE. CABLES SHALL BE INSTALLED AT LAYERS
- AS INDICATED. 2. THE TRENCH DETAIL BELOW SHOWS A SAMPLE NUMBER OF DC FEEDER CABLES FROM DC COMBINER BOXES. SPECIFIC CABLE QUANTITIES ARE SHOWN IN RESPECTIVE DETAIL SECTION.
- 3. TRENCHING MUST COMPLY WITH THE LATEST STANDARDS. 4. CLEAN FILL REQUIREMENTS: TRENCHING BEDDING SHALL BE SAND OR ROCK-FEE FILL SCREENED TO A MAXIMUM 1/4" SIZE AS A CUSHING (FREE OF SHARP EDGE MATERIAL, ROTTING WOOD OR ORGANIC MATTER THAT MIGHT ATTRACT INSECTS). THE CABLES SHALL BE COVERED WITH

"CLEAN FILL" SAND OR SOFT EARTH, FREE FROM STONES, ROCKS OR OTHER MATERIAL

- THAT MAY DAMAGE THE CABLE DURING BACKFILL. 5. THE CABLES CROSS-SECTION AND THE NUMBER SHOWN IS ONLY AN EXAMPLE. ALL CABLES SHALL BE IN ACCORDANCE WITH STANDARDS AND SHALL BE SIZED ACCORDING TO USE AND TYPE OF
- INSTALLATION. UNTREATED NATIVE SOIL
- CLEAN, DRY BACKFILL CUSHION EARTH UNDISTURBED
- 1. CONDUCTORS TO BE 1000V RATED FOR DIRECT BURIIAL. MEDIUM VOLTAGE CONDUCTORS FROM PS1 TO BE RATED FOR CLASS 35KV, AND
- 2. CONDUCTORS OF THE SAME CIRCUIT TO BE NEXT TO EACH OTHER; COMBINER CIRCUITS TO BE SPACED 4.5" FROM EACH OTHER UNLESS
- POSTED OTHERWISE (HORIZONTAL/VERTICAL DIRECTIONS). 3. COMMUNICATIONS TO BE BURIED 1' AWAY FROM ALL POWER CONDUCTORS. USE DIRECT BURY RATED FIBER CABLE.
- 4. 3" OR 4" PVC SCH80 JUMP-CONDUIT SHALL BE UTILIZED FOR ROW-TO-ROW STRING CIRCUITS WIRING.

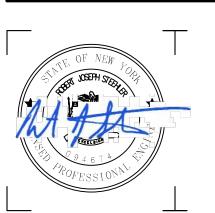
MEDIUM VOLTAGE CONDUCTORS FROM PS2 TO BE RATED FOR CLASS 15KV.

5. POWER SUPPLY CABLES TO ARC FAULT CIRCUIT INTERRUPTION CIRCUITS SHALL BE LOCATED AT A MINIMUM 1' FROM DC CIRCUITS. 6. CONTRACTOR SHALL SIZE THE ROW-TO-ROW JUMPER CONDUIT FOR THE CONDUCTORS USED, WITH PVC SCHEDULE 80. A TOTAL OF 60 #10 HOMERUN CABLES CAN FIT INTO A STANDARD 4" PVC CONDUIT. CONTACT THE ENGINEER IF ADDITIONAL GUIDANCE IS REQUIRED.

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